- 1. THE CONTRACTOR SHALL OBTAIN AND HAVE AVAILABLE COPIES OF THE APPLICABLE GOVERNING AGENCY STANDARDS AT THE JOB SITE DURING THE RELATED CONSTRUCTION OPERATIONS.
- 2. CONTRACTOR SHALL ENSURE THAT ALL NECESSARY PERMITS HAVE BEEN OBTAINED PRIOR TO COMMENCING WORK.
- 3. THE CONTRACTOR SHALL BE RESPONSIBLE FOR VERIFYING THE LOCATION, DIMENSION AND DEPTH OF ALL EXISTING UTILITIES PRIOR TO CONSTRUCTION WHETHER SHOWN ON THESE PLANS OR NOT. UTILITIES OTHER THAN THOSE SHOWN MAY EXIST ON THIS SITE. ONLY THOSE UTILITIES WITH EVIDENCE OF THEIR INSTALLATION VISIBLE AT GROUND SURFACE OR SHOWN ON RECORD DRAWING PROVIDED BY OTHERS ARE SHOWN HEREON. EXISTING UNDERGROUND UTILITY LOCATIONS SHOWN ARE APPROXIMATE ONLY AND ARE SUBJECT TO A DEGREE OF UNKNOWN VARIATION. SOME UNDERGROUND LOCATIONS SHOWN HEREON MAY HAVE BEEN TAKEN FROM PUBLIC RECORDS. BARGHAUSEN CONSULTING ENGINEERS, INC. ASSUMES NO LIABILITY FOR THE ACCURACY OF PUBLIC RECORDS OR RECORDS OF OTHERS. IF CONFLICTS SHOULD OCCUR, THE CONTRACTOR SHALL CONSULT BARGHAUSEN CONSULTING ENGINEERS, INC., TO RESOLVE ALL PROBLEMS PRIOR TO PROCEEDING WITH CONSTRUCTION.
- 4. IT IS THE RESPONSIBILITY OF THE CONTRACTOR TO REVIEW ALL OF THE DRAWINGS AND SPECIFICATIONS ASSOCIATED WITH THE PROJECT WORK SCOPE PRIOR TO THE INITIATION OF CONSTRUCTION. SHOULD THE CONTRACTOR FIND A CONFLICT WITH THE DOCUMENTS RELATIVE TO THE SPECIFICATIONS OR THE RELATIVE CODES, IT IS THE CONTRACTOR'S RESPONSIBILITY TO NOTIFY THE PROJECT ENGINEER OF RECORD IN WRITING PRIOR TO THE START OF CONSTRUCTION. FAILURE BY THE CONTRACTOR TO NOTIFY THE PROJECT ENGINEER SHALL CONSTITUTE ACCEPTANCE OF FULL RESPONSIBILITY BY THE CONTRACTOR TO COMPLETE THE SCOPE OF WORK AS DEFINED BY THE DRAWINGS AND IN FULL COMPLIANCE WITH LOCAL REGULATIONS AND CODES.
- 5. IT SHALL BE THE CONTRACTOR'S RESPONSIBILITY TO NOTIFY THE APPROPRIATE UTILITIES INVOLVED PRIOR TO CONSTRUCTION.
- 6. INSPECTION OF SITE WORK WILL BE ACCOMPLISHED BY A REPRESENTATIVE OF THE GOVERNING JURISDICTION. INSPECTION OF PRIVATE FACILITIES WILL BE ACCOMPLISHED BY A REPRESENTATIVE OF THE OWNER. IT SHALL BE THE CONTRACTOR'S RESPONSIBILITY TO NOTIFY THE INSPECTOR 24 HOURS IN ADVANCE OF BACKFILLING ALL CONSTRUCTION.
- 7. PRIOR TO ANY CONSTRUCTION OR DEVELOPMENT ACTIVITY THE CONTRACTOR SHALL CONTACT THE AGENCY AND/OR UTILITY INSPECTION PERSONNEL AND ARRANGE ANY REQUIRED PRE-CONSTRUCTION MEETING(S). CONTRACTOR SHALL PROVIDE ONE WEEK MIN. ADVANCE NOTIFICATION TO OWNER, FIELD ENGINEER AND ENGINEER OF PRE-CONSTRUCTION MEETINGS.
- S. THE CONTRACTOR IS RESPONSIBLE FOR WORKER AND SITE SAFETY AND SHALL COMPLY WITH THE LATEST OSHA STANDARDS AND REGULATIONS, OR ANY OTHER AGENCY HAVING JURISDICTION FOR EXCAVATION AND TRENCHING PROCEDURES. THE CONTRACTOR IS RESPONSIBLE FOR DETERMINING THE "MEANS AND METHODS" REQUIRED TO MEET THE INTENT AND PERFORMANCE CRITERIA OF OSHA, AS WELL AS ANY OTHER ENTITY THAT HAS JURISDICTION FOR EXCAVATION AND/OR TRENCHING PROCEDURES.
- 9. THE CONTRACTOR SHALL BE RESPONSIBLE FOR PROVIDING ADEQUATE SAFEGUARDS, SAFETY DEVICES, PROTECTIVE EQUIPMENT, FLAGGERS, AND ANY OTHER NEEDED ACTIONS TO PROTECT THE LIFE, HEALTH, AND SAFETY OF THE PUBLIC, AND TO PROTECT PROPERTY IN CONNECTION WITH THE PERFORMANCE OF WORK COVERED BY THE CONTRACTOR. ANY WORK WITHIN THE TRAVELED RIGHT-OF-WAY THAT MAY INTERRUPT NORMAL TRAFFIC FLOW SHALL REQUIRE AT LEAST ONE FLAGGER FOR EACH LANE OF TRAFFIC AFFECTED.

10. PROTECTIVE MEASURES SHALL BE TAKEN BY THE CONTRACTOR TO PROTECT ALL ADJACENT PUBLIC AND PRIVATE

PROPERTIES AT ALL TIMES DURING CONSTRUCTION. THE CONTRACTOR SHALL BE RESPONSIBLE FOR PROTECTION OF ALL EXISTING UTILITY SERVICES THAT ARE TO REMAIN OPERATIONAL WITHIN THE CONSTRUCTION AREA WHETHER SHOWN OR NOT SHOWN ON THE PLANS.

11. TWO (2) COPIES OF THESE APPROVED PLANS MUST BE ON THE JOB SITE WHENEVER CONSTRUCTION IS IN PROGRESS.

ONE (1) SET WITH RECORDS OF AS-BUILT INFORMATION SHALL BE SUBMITTED TO BARGHAUSEN CONSULTING ENGINEERS,

- INC. AT COMPLETION OF PROJECT.

 12. CONTRACTOR SHALL OBTAIN SERVICES OF A LICENSED LAND SURVEYOR TO STAKE HORIZONTAL CONTROL FOR ALL NEW IMPROVEMENTS. STAKING CONTROL SHALL BE TAKEN FROM ELECTRONIC PLAN FILES PROVIDED BY BARGHAUSEN CONSULTING ENGINEERS, INC.
- 13. CONTRACTOR SHALL REQUEST FROM BARGHAUSEN CONSULTING ENGINEERS INC., PRIOR TO ANY CONSTRUCTION STAKING OR CONSTRUCTION WORK, A FORMAL CONSTRUCTION RELEASE PLAN SET OR SPECIFIC RELEASE IN WRITING. THE APPROVED AGENCY PERMIT DRAWINGS WILL NOT BE CONSIDERED CONSTRUCTION RELEASE PLANS BY BARGHAUSEN CONSULTING ENGINEERS, INC HAS GIVEN A FORMAL WRITTEN RELEASE OR ISSUED A CONSTRUCTION RELEASE PLAN SET.

GEOTECHNICAL REPORT

NOTES:

1. THE FOLLOWING GEOTECHNICAL REPORTS FOR THE SITE SHALL BE CONSIDERED PART OF THESE CONSTRUCTION DOCUMENTS:

GEOTECHNICAL ENGINEERING REPORT TERRACON CONSULTANTS, INC. PROJECT NO. CB235035 DATE: MARCH 24, 2023 TERRACON CONSULTANTS, INC. 23041 AVENIDA DE LA CARLOTA, SUITE 350 LAGUNA HILLS, CA 92653

- . IT SHALL BE THE RESPONSIBILITY OF THE CONTRACTOR TO ENSURE THAT ALL PROVISIONS OF THE SOILS REPORT FOR THE SITE BE OBSERVED AND COMPLIED WITH DURING ALL PHASES OF THE SITE PREPARATION, GRADING OPERATIONS, FOUNDATION, SLAB, AND PAVING CONSTRUCTION.
- 3. ANY PROVISIONS OF THE SOILS REPORT WHICH CONFLICT WITH INFORMATION SHOWN ELSEWHERE ON THESE DRAWINGS, OR WHICH REQUIRE FURTHER CLARIFICATION, SHALL BE BROUGHT TO THE ATTENTION OF THE ARCHITECT/ENGINEER FOR DETERMINATION.
- 4. A REPRESENTATIVE OF THE SOILS ENGINEER SHALL BE AVAILABLE TO OBSERVE AND APPROVE THE EARTHWORK OPERATIONS AND TO VERIFY FIELD CONDITIONS AS WORK PROCEEDS. THE SOILS ENGINEER SHALL SUBMIT FIELD REPORTS CERTIFYING THAT THE METHODS AND MATERIALS OF THE EARTHWORK OPERATIONS WERE IN ACCORDANCE WITH THE RECOMMENDATIONS OF THE SOILS INVESTIGATION AND THAT THE WORK WAS PERFORMED TO HIS/HER SATISFACTION.
- 5. THE SOILS ENGINEER SHOULD BE NOTIFIED AT LEAST FIVE (5) WORKING DAYS PRIOR TO ANY SITE CLEARING OR GRADING.

tent, info "Materials			LEGEND):		
_	PROF	POSED		EXIS	TING	
_	CURB AND GUTTER		CURB		 LUMINAIRE (LUM.)	$\leftrightarrow \rightarrow$
designs, ectively,	BARRIER CURB		PAINT STRIPE		YARD LIGHT	-
	CONCRETE	d	CONCRETE	V	UTILITY POLE	-
ossociated logos, distinctive otographs, and pictures (col	ASPHALT		CONTOUR WATER	— 91 — — 8"W > —	JUNCTION BOX (AS NOTED)	
gos. d pic	SAWCUT		SANITARY	— — 6°°5 — —	CATCH BASIN	
od logo	CONTOUR	432	STORM	- <u>12"_D</u> -	STORM DRAIN MANHOLE/INLET	
all associated photographs,	WATER WATER METER		OVERHEAD POWER	— О/Н —	GAS METER	.GV.
all as	STORM		GAS	—— G ——	GAS VALVE	Ğ ^V
•	SANITARY		DOUBLE CHECK VALVE		WATER VALVE (WV)	WV
BROS. and illustrations,	GAS POWER	G	ASPHALT		FIRE HYDRANT(FH) CONNECTION(FDC)	Q A
_	PAINT STRIPE		BUILDING LINE		WATER METER	\blacksquare
e DUICH designs,	TYPE 1 CATCH BASIN		OH/UG TEL. LINE	T(XX)	SIGN	Д
"The name grophics, de	TYPE 2 CATCH BASIN SANITARY SEWER CLEANOUT	. •	TREE		DIRECTIONAL ARROW BOLLARD	•

COVER SHEET PRIVATE ACCESS DRIVE MUTUAL DRIVEWAY BK. 13311, PAGE 1254 SCALE: 1"=20" VARIABLE WIDTH SEWER/WATER EASEMENT BK. 11282, PAGE 1413 PRIVATE ACCESS DRIVE **SURVEYOR ENGINEER OWNER** BB HOLDINGS CA, LLC BARGHAUSEN CONSULTING ENGINEERS, INC. TERRAMARK, INC.

DUTCH BROS. COFFEE - CA7101 - LAGUNA HILLS, CA

24801 ALICIA PARKWAY, LAGUNA HILLS, CA

DEVELOPER

ATTN: DANIEL BATTY

110 SW 4TH STREET

GRANTS PASS, OR 97526

DUTCH BROS. COFFEE 110 SW 4TH STREET GRANTS PASS, OR 97526 TEL: (916) 765–7270 CONTACT: JOHN CAGLIA

BUILDING ARCHITECT

ARMET DAVIS NEWLOVE & ASSOCIATES 1330 OLYMPIC BLVD.
SANTA MONICA, CA 90404
TEL: (310) 452-5533
CONTACT: PAUL DEPPE

18215 72ND AVE. SOUTH

CONTACT: HAL P. GRUBB, P.E.

KENT, WA 98032

TEL: (425) 251-6222

GEOTECHNICAL

BEAVERTON, OR 97008

TEL: (503) 860-2255

TERRACON CONSULTANTS, INC.
23041 AVENIDA DE LA CARLOTA, SUITE 350
LAGUNA HILLS, CA 92653
TEL: (949) 261-0051
CONTACT: SCOTT G. LAWSON, P.E., G.E.

8196 SW HALL BOULEVARD, SUITE 111

CONTACT: MICHAEL A. HOFFMAN. L.S.

_ LANDSCAPE ARCHITECT

EVERGREEN DESIGN GROUP 1600 BROADWAY, SUITE 1600 DENVER, CO 80202 TEL: (800) 680-6630 CONTACT: RODNEY MCNABB, L.L.A.

MONUMENT PROTECTION NOTE:

ALL EXISTING SURVEY MONUMENTS ARE TO BE PRESERVED PER CALIFORNIA SENATE BILL 1467. IT IS THE CONTRACTOR'S RESPONSIBILITY TO ENSURE THAT MONUMENTS ARE PROPERLY PROTECTED AND/OR PERPETUATED. IF ANY OF THE MONUMENTS ARE DISTURBED OR ARE NEAR THE AREA OF CONSTRUCTION. A LICENSED SURVEYOR MUST CONFIRM THAT THE MONUMENTS HAVE BEEN PROTECTED AND/OR PERPETUATED AND THE APPROPRIATE DOCUMENTATION HAS BEEN RECORDED.CONTRACTOR SHALL BE FULLY RESPONSIBLE FOR OBTAINING PERMITS FROM ANY JURISDICTIONS HAVING AUTHORITY FOR REMOVING AND REPLACING ALL SURVEY MONUMENTATION THAT MAY BE AFFECTED BY CONSTRUCTION ACTIVITY. UPON COMPLETION OF CONSTRUCTION, ALL MONUMENTS DISPLACED, REMOVED, OR DESTROYED SHALL BE REPLACED BY A REGISTERED LAND SURVEYOR, AT THE COST AND AT THE DIRECTION OF THE CONTRACTOR, PURSUANT TO THESE REGULATIONS. THE APPROPRIATE FORMS FOR REPLACEMENT OF SAID MONUMENTATION SHALL ALSO BE THE RESPONSIBILITY OF THE CONTRACTOR.

HORIZONTAL CONTROL NOTE:

CONTRACTOR SHALL HAVE ALL PROPERTY LINES, CURB, SIDEWALK, STRUCTURES, CONCRETE PADS AND ANY OTHER ABOVE GROUND PERMANENT STRUCTURE DEPICTED ON THESE PLANS STAKED FOR CONSTRUCTION BY A LICENSED SURVEYOR. LICENSED SURVEYOR SHALL STAKE ALL ITEMS USING COORDINATE GEOMETRY (RECTIFIED TO SITE CONTROL) CONTAINED IN CAD DRAWING FILES PROVIDED BY BARGHAUSEN CONSULTING ENGINEERS, INC. IT IS THE CONTRACTOR'S RESPONSIBILITY TO RETRIEVE LATEST CAD FILES FROM BARGHAUSEN CONSULTING ENGINEERS INC., REFLECTING ANY ISSUED PLAN REVISIONS. BARGHAUSEN CONSULTING ENGINEERS SHALL IMMEDIATELY BE NOTIFIED OF ANY DISCREPANCIES PRIOR TO THE START OF CONSTRUCTION.

UTILITY CONFLICT NOTE:

THE CONTRACTOR SHALL BE RESPONSIBLE FOR VERIFYING THE LOCATION, DIMENSION, AND DEPTH OF ALL EXISTING UTILITIES WHETHER SHOWN ON THESE PLANS OR NOT BY POTHOLING THE UTILITIES AND SURVEYING THE HORIZONTAL AND VERTICAL LOCATION PRIOR TO CONSTRUCTION. THIS SHALL INCLUDE CALLING UTILITY LOCATE @ 811 AND THEN POTHOLING ALL OF THE EXISTING UTILITIES AT LOCATIONS OF NEW UTILITY CROSSINGS TO PHYSICALLY VERIFY WHETHER OR NOT CONFLICTS EXIST. LOCATIONS OF SAID UTILITIES AS SHOWN ON THESE PLANS ARE BASED UPON THE UNVERIFIED PUBLIC INFORMATION AND ARE SUBJECT TO VARIATION. IF CONFLICTS SHOULD OCCUR, THE CONTRACTOR SHALL NOTIFY BARGHAUSEN CONSULTING ENGINEERS, INC. TO RESOLVE ALL PROBLEMS PRIOR TO PROCEEDING WITH CONSTRUCTION.

BENCHMARK:

ELEVATIONS SHOWN HEREON AREA BASED ON ORANGE COUNTY BENCHMARK 3HH-3-777, WHICH BEARS AN ELEVATION OF 340.572' ON THE NORTH AMERICAN VERTICAL DATUM OF 1988, LEVEL YEAR 1991.

FLOOD ZONE:

THE FLOOD ZONE DESIGNATION FOR THE SUBJECT PROPERTY IS ZONE X (0.2% ANNUAL CHANCE FLOOD HAZARD), ACCORDING TO FLOOD INSURANCE RATE MAP NUMBER 06059C0427J, EFFECTIVE DECEMBER 3, 2009.

EXISTING TOPOGRAPHY / SURVEY INFORMATION NOTE:

AN A.L.T.A./N.S.P.S. TOPOGRAPHIC AND BOUNDARY SURVEY DATED APRIL 14, 2023; PERFORMED BY TERRAMARK, INC. AND HAS BEEN PROVIDED TO BARGHAUSEN CONSULTING ENGINEERS, INC. BARGHAUSEN CONSULTING ENGINEERS, INC. HAS NOT VERIFIED THE ACCURACY OR COMPLETENESS OF THE INFORMATION

SITE DESIGN HAS BEEN BASED ON ABOVE REFERENCED SURVEY. IT IS THE CONTRACTOR'S RESPONSIBILITY TO COORDINATE WITH THE OWNER TO HAVE ALL IMPROVEMENTS FIELD VERIFIED PRIOR TO CONSTRUCTION. DISCREPANCIES SHALL BE BROUGHT TO THE ATTENTION OF BARGHAUSEN CONSULTING ENGINEERS, INC. IMMEDIATELY.

SITE LOCATION

Sentley In.

Costeau St.

VICINITY MAP

PROJECT DATA

NAME: DUTCH BROS COFFEE - LAGUNA HILLS, CA
ADDRESS: 24801 ALICIA PARKWAY
LAGUNA HILLS, CA 92653
GROSS PROJECT AREA: 29,624 SF (0.68 ACRES)
PARCEL AREA: 33,540 SF (0.77 ACRES)
BUILDING: 950 SF

DEVELOPMENT STANDARDS: LOT COVERAGE: 50% MAX. LANDSCAPE COVERAGE: 15% MIN.

PROPOSED BUILDING SETBACKS

MINIMUM FRONT YARD = 10FT

MINIMUM SIDE YARD = 10FT

MINIMUM REAR YARD = 20FT ABUTTING RESIDENTIAL, 10FT ABUTTING NON-RESIDENTIAL

ADJACENT ZONING:

THE PARCEL IS BOUNDED TO THE NORTH, SOUTH, AND WEST BY PROPERTIES ZONED AS NMU (NEIGHBORHOOD MIXED USE). THE EASTERN BORDER OF THE PROPERTY IS BOUNDED BY ALICIA PARKWAY.

PARKING SPACES:

- REQUIRED: 1 SPACES (1 SPACE PER 1000SF GROSS FLOOR AREA)
- PROPOSED: 6 REGULAR SPACES, 1 ADA STALL
- BICYCLE: 4 SPACES

PROPOSED GROUND COVER SUMMARY (ON-SITE)

BUILDINGS:	950 SF	(3.2%)
OUTDOOR PATIO:	335 SF	(1.2%)
PARKING, MANEUVERING, TRASH ENC.:	13,140 SF	(44.4%)
WALKWAYS:	1,865 SF	(6.3%)
LANDSCAPE:	13,319 SF	(45.0%)
	29,624 SF	(100.00%
ANDSCAPE BREAKDOWN:		
PERIMETER:	2,051 SF	(15.4%)

11,268 SF

13,319 SF

(84.6%<u>)</u>

(100.00%)

Sheet List Table Sheet Title Sheet Number **COVER SHEET** C1.1 EXISTING CONDITIONS MAP C2.0 PRELIMINARY SITE PLAN C2.1 COLORED CONCEPTUAL SITE PLAN PRELIMINARY DRAINAGE AND GRADING PLAN DETENTION SYSTEM PROFILE C4.0 PRELIMINARY UTILITY PLAN UTILITY DETAILS AND NOTES C5.0 DETAILS AND NOTES LANDSCAPE PLANTING PLAN LANDSCAPE PLANTING SPECIFICATIONS AND DETAILS

By Ckd. Appr. Revision

COVER SHEET

24801 ALICIA PARKWAY

No. Dote

PROFESSIONAL CITY OF CALIFORNIA

lorizontal
1" = 20'
Vertical

ssigned NRN


awn NRN

necked MTL

pproved HPG


ing Engineers, Inc. 4 Avenue South 98032 22 barghausen.com


Consulting El 18215 72nd Avenu Kent, WA 98032 425.251.6222

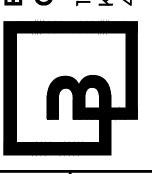


22775
Sheet
C1.0
2019 DB
Achising USA, LLC

PRELIMINARY NOT FOR CONSTRUCTION

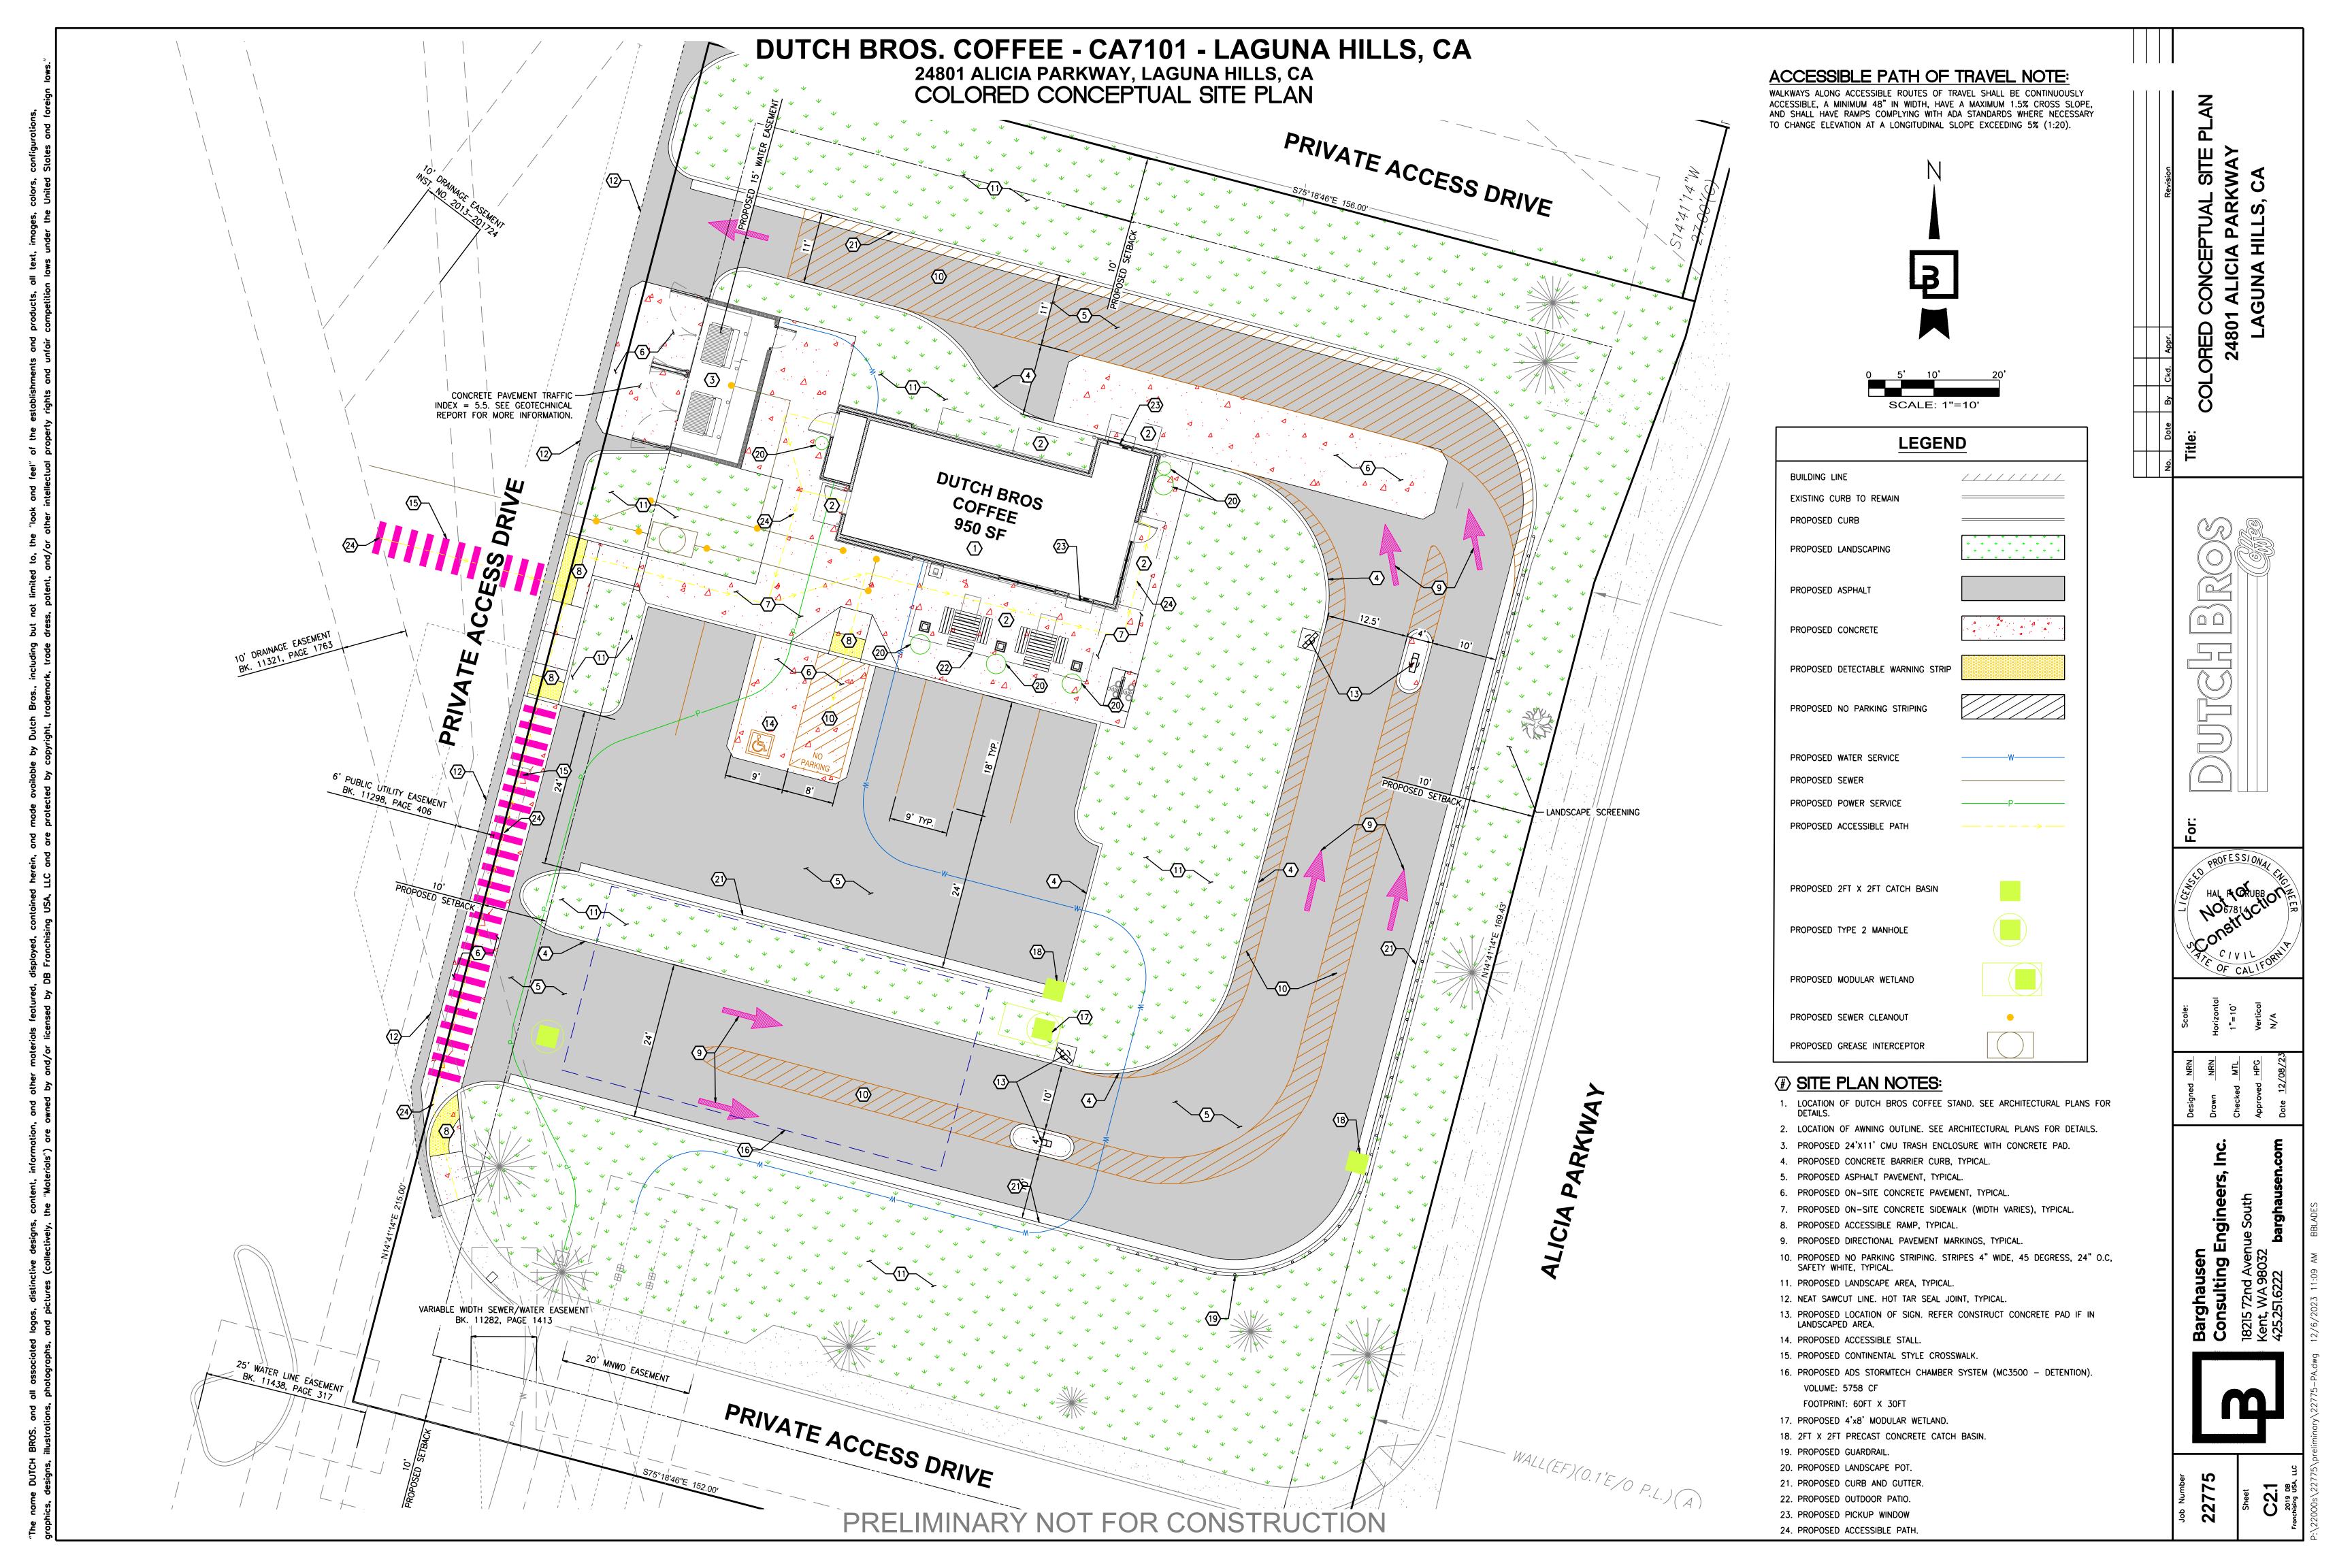

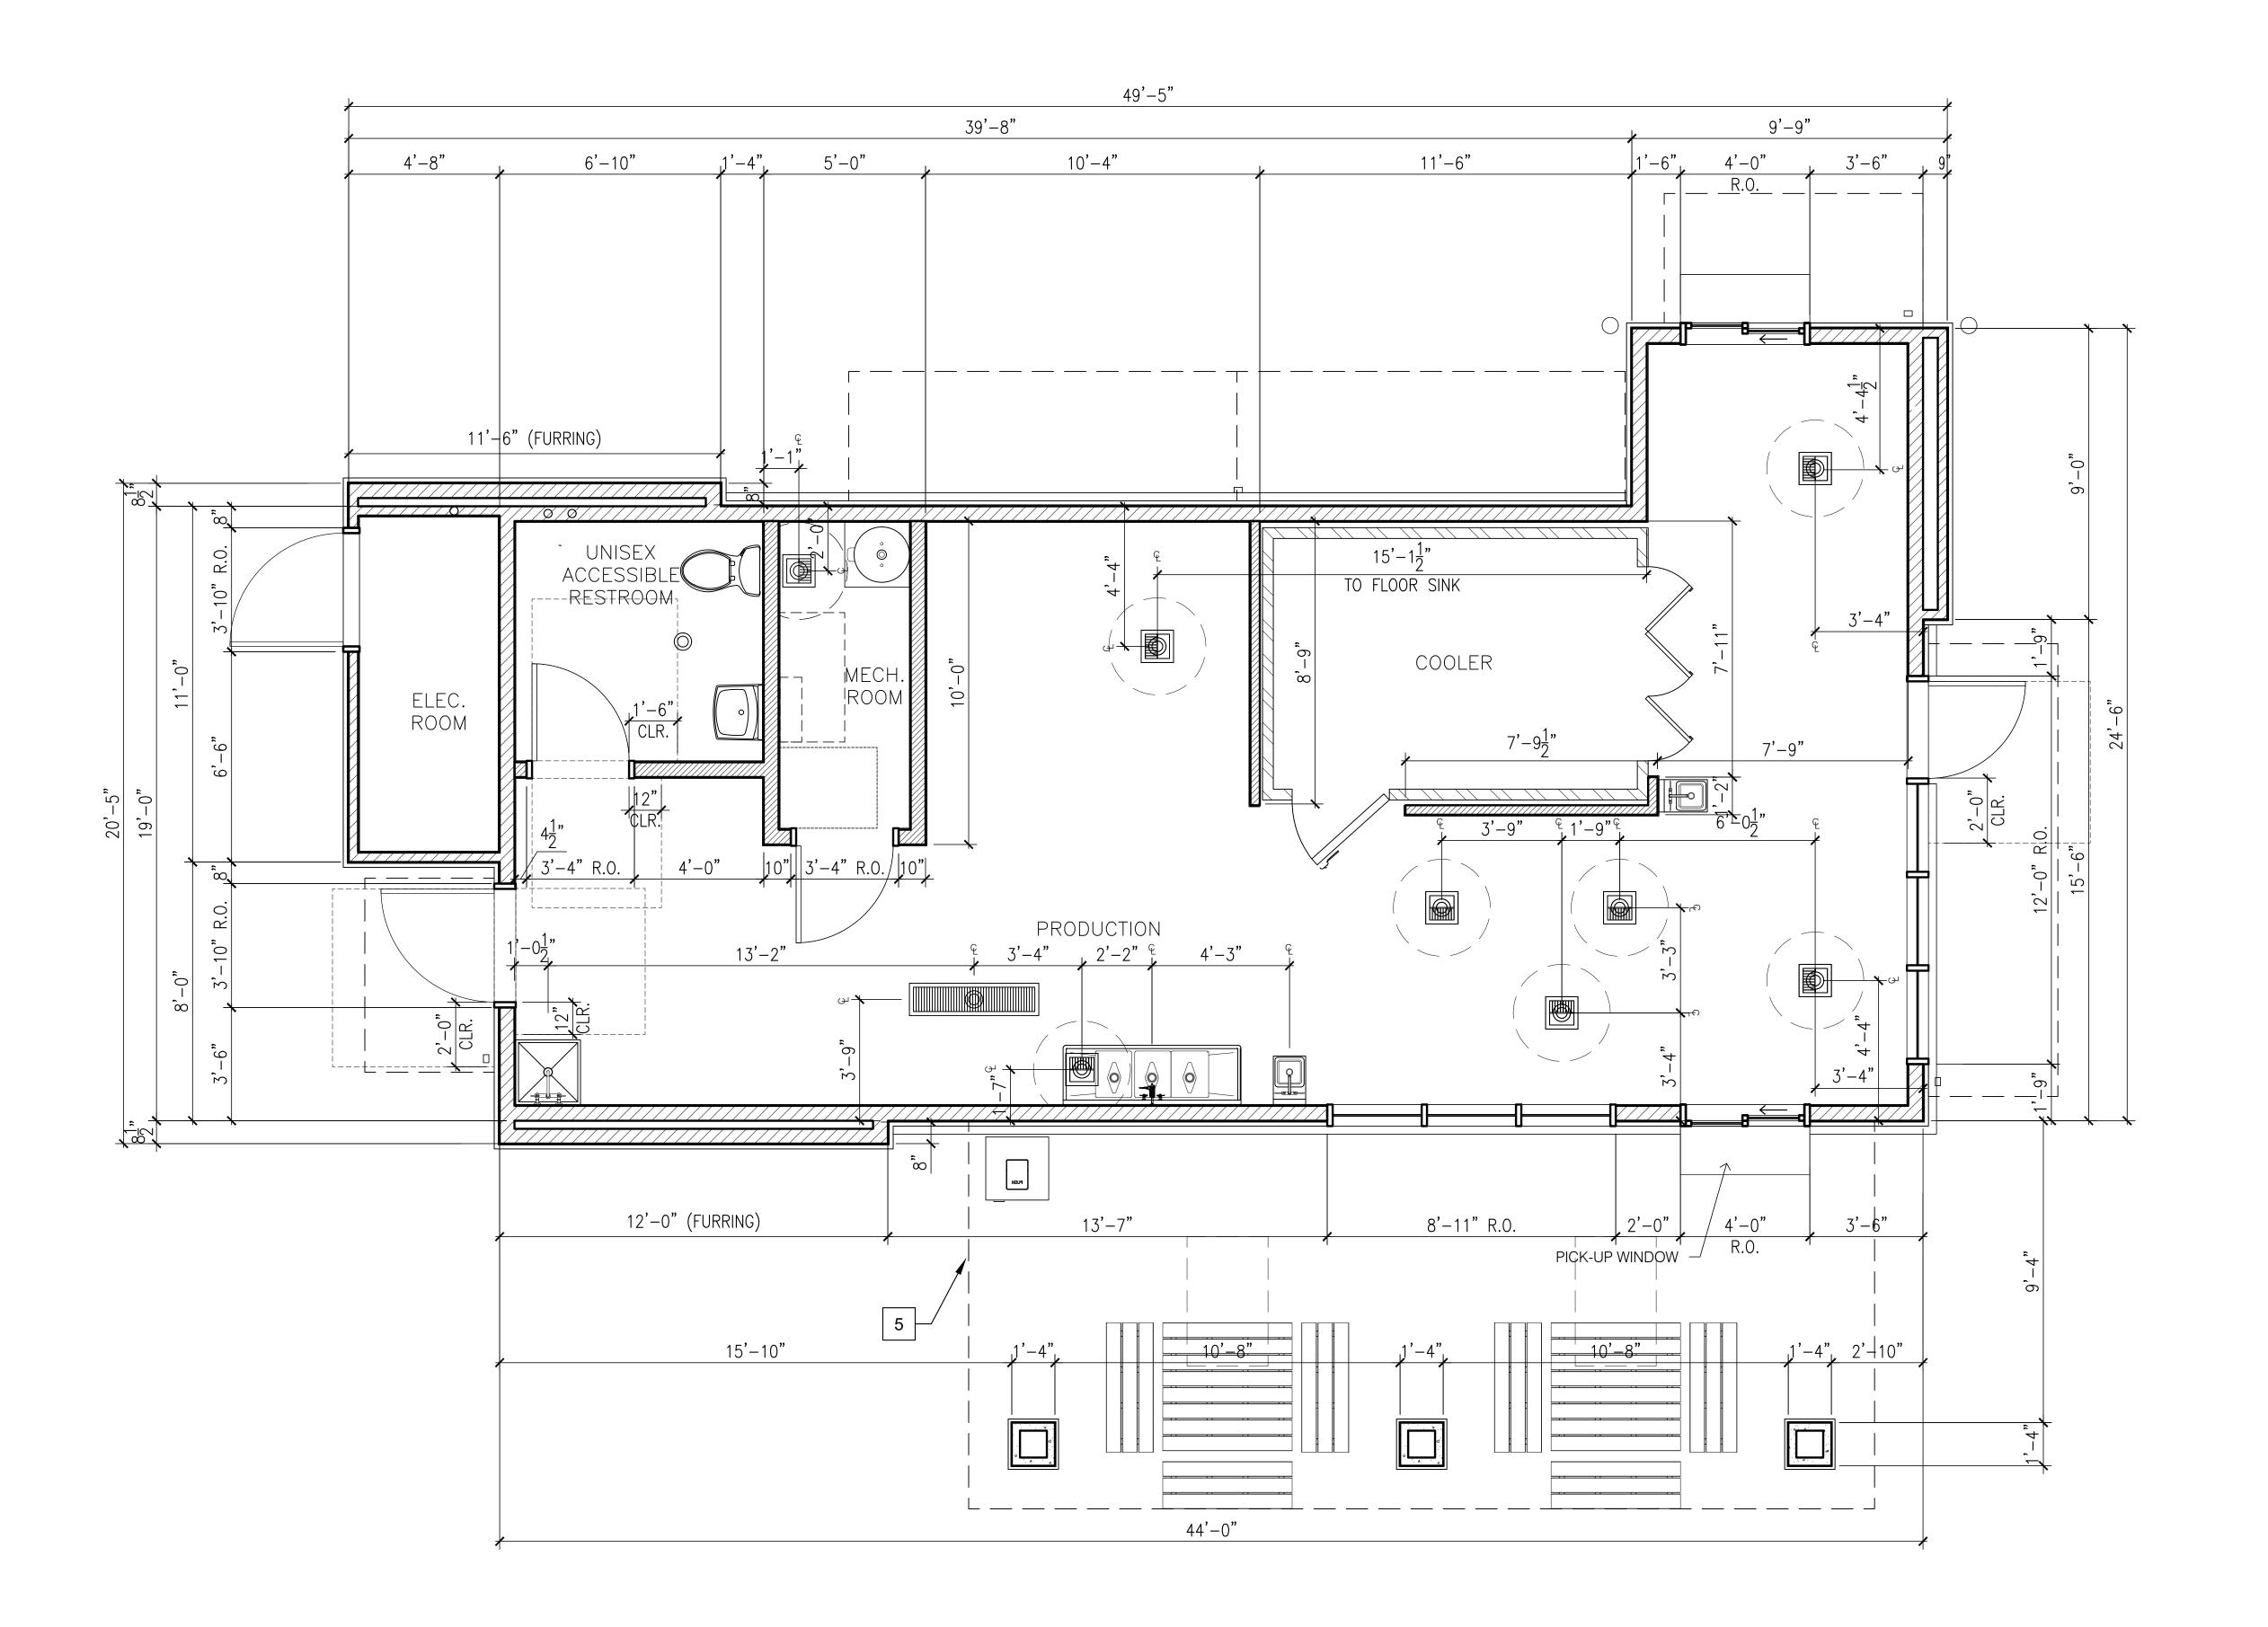

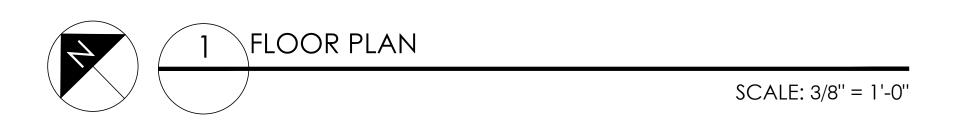



ARMÉT DAVIS NEWLOVE & ASSOCIATES, AIA ARCHITECTS

1330 OLYMPIC BLVD. SANTA MONICA, CALIFORNIA 90404 PH 310 452-5533 FAX 310 450-4742

THE USE OF THESE PLANS AND SPECIFICATIONS SHALL BE RESTRICTED TO THE ORIGINAL SITE FOR WHICH THEY WERE PREPARED AND PUBLICATION THEREOF IS EXPRESSLY LIMITED TO SUCH USE. RE-USE, REPRODUCTION OR PUBLICATION BY ANY METHOD, IN WHOLE OR IN PART, IS PROHIBITED. TITLE TO THE PLANS AND SPECIFICATIONS REMAINS WITH THE ARCHITECT WITHOUT PREJUDICE. VISUAL CONTACT WITH THESE PLANS AND SPECIFICATIONS SHALL CONSTITUTE PRIMA FACIE EVIDENCE OF THE ACCEPTANCE OF THE RESTRICTIONS.



DATE: 04/28/2023 REV: DATE: DESCRIPTION:

FLOOR PLAN/ DETAILS/ SCHEDULES

SHEET NUMBER:

ID TAG	MATERIAL	MANUFACTURER	MODEL	REMARKS
ZONE 1 (BO	DDY)			
1A	EXTERIOR CEMENT PLASTER	SHERWIN WILLIAMS	8656-11295 - BLDG DB DARK GRAY	3-COAT SYSTEM W/ ACRYLIC MEDIUM SAND FINISH; REVEALS AS SHOWN
1B	EXTERIOR CEMENT PLASTER	SHERWIN WILLIAMS	SW7069 - IRON ORE	3-COAT SYSTEM W/ ACRYLIC MEDIUM SAND FINISH; REVEALS AS SHOWN
ZONE 2 (TO	WER) (Z2)			
2	METAL PANEL	WESTERN STATES METAL ROOFING	WESTERN WAVE, 24 ga.	ORIENTATION: HORIZONTAL; COLOR: BLDG DB BLUE
ZONE 3 (3'-2	2" BASE)			
3	BRICK VENEER	BELDEN BRICK	TITANIUM VELOUR	BRICK VENEER STILL TO MATCH
ZONE 4 (FR	AMED CANOPY)			
4	FASCIA	WESTERN STATES METAL ROOFING	METAL FASCIA	COLOR TO MATCH SHERWIN WILLIAMS SW7069 IRON ORE
5	SOFFIT	HEWN ELEMENTS	NATURAL NORTHWESTERN SPRUCE	1X6, T&G, ⅓" REVEAL
6	COLUMNS	BELDEN BRICK	TITANIUM VELOUR	





an

ARMÉT DAVIS NEWLOVE & ASSOCIATES, AIA ARCHITECTS

1330 OLYMPIC BLVD.
SANTA MONICA, CALIFORNIA 90404
PH 310 452-5533 FAX 310 450-4742

THE USE OF THESE PLANS AND SPECIFICATIONS SHALL BE RESTRICTED TO THE ORIGINAL SITE FOR WHICH THEY WERE PREPARED AND PUBLICATION THEREOF IS EXPRESSLY LIMITED TO SUCH USE. RE-USE, REPRODUCTION OR PUBLICATION BY ANY METHOD, IN WHOLE OR IN PART, IS PROHIBITED. TITLE TO THE PLANS AND SPECIFICATIONS REMAINS WITH THE ARCHITECT WITHOUT PREJUDICE. VISUAL CONTACT WITH THESE PLANS AND SPECIFICATIONS SHALL CONSTITUTE PRIMA FACIE EVIDENCE OF THE ACCEPTANCE OF THE RESTRICTIONS.



ding Store

0

Project No: CA7

Dutch Bros Coffee - New Free
2550 - A2 PROTOTYPE
24901 ALICIA PKWY.
LAGUNA HILL, CA 92653

DOTCH DOTCH DESCRIPTION:

SHEET NAME:

BUILDING ELEVATIONS COLOR

SHEET NUMBER:

A6.1













ARMÉT DAVIS NEWLOVE & ASSOCIATES, AIA ARCHITECTS

1330 OLYMPIC BLVD. SANTA MONICA, CALIFORNIA 90404 PH 310 452-5533 FAX 310 450-4742

THE USE OF THESE PLANS AND SPECIFICATIONS SHALL BE RESTRICTED TO THE ORIGINAL SITE FOR WHICH THEY WERE PREPARED AND PUBLICATION THEREOF IS EXPRESSLY LIMITED TO SUCH USE. RE-USE, REPRODUCTION OR PUBLICATION BY ANY METHOD, IN WHOLE OR IN PART, IS PROHIBITED. TITLE TO THE PLANS AND SPECIFICATIONS REMAINS WITH THE ARCHITECT WITHOUT PREJUDICE. VISUAL CONTACT WITH THESE PLANS AND SPECIFICATIONS SHALL CONSTITUTE PRIMA FACIE EVIDENCE OF THE ACCEPTANCE OF THE RESTRICTIONS.





DATE: 04/28/2023 REV: DATE: DESCRIPTION:

SHEET NAME: 3D RENDERINGS

SHEET NUMBER:

22775
Sheet
D-1
anothising USA, LLC

DUTCH BROS. COFFEE - CA7101 - LAGUNA HILLS, CA

24801 ALICIA PARKWAY, LAGUNA HILLS, CA

PLANT SCHEDULE

BLUE FINGERS

- EXISTING PALM TREE

TO BE REMOVED (TYP.)

- HEADLIGHT SCREENING

- EXISTING CARROTWOOD TREE

- EX. WALL AT PROPERTY LINE

EXISTING CARROTWOOD TREE

36" TALL AT PLANTING

TO REMAIN (TYP.)

TO REMAIN (TYP.)

HEADLIGHT SCREENING

- EXISTING PALM TREE

TO BE REMOVED (TYP.)

EX. WALL AT PROPERTY LINE

1"=20'-0"SCALE NORTH

36" TALL AT PLANTING

- EX. SIDEWALK

- EX. SIDEWALK

SYMBOL	BOTANICAL / COMMON NAME	SIZE	WUCOLS	CAL	HEIGHT		QTY
TREES							
	PLATANUS RACEMOSA 'ROBERTS' ROBERTS CALIFORNIA SYCAMORE	36" BOX	М	2.5" CAL	10`-12`		3
*	ULMUS PARVIFOLIA 'TRUE GREEN' TRUE GREEN LACEBARK ELM	36" BOX	М	1.5" CAL.	6`-8`		7
SYMBOL	BOTANICAL / COMMON NAME	SIZE	WUCOLS	MATURE SIZE (W`XH`)	ADDITIONAL	SPACING	QTY
SHRUBS							
£	AGAVE X 'BLUE FLAME' BLUE FLAME AGAVE	5 GAL	VL	4X3		60" o.c.	16
	ALOE STRIATA CORAL ALOE	5 GAL	L	2X2		36" o.c.	48
	CARISSA MACROCARPA 'GREEN CARPET' GREEN CARPET NATAL PLUM	5 GAL	L	4X2		48" o.c.	97
	DIETES BICOLOR FORTNIGHT LILY	3 GAL	L	3X3		36" o.c.	47
	DIETES GRANDIFLORA 'SUNSTRIPE' YELLOW STRIPED FORTNIGHT LILY	3 GAL	L	3X4		48" o.c.	79
(FRANGULA CALIFORNICA 'EVE CASE' EVE CASE COFFEEBERRY	5 GAL	L	6X8		66" o.c.	9
+	LOMANDRA LONGIFOLIA 'ROMA 13' PLATINUM BEAUTY® VARIEGATED MAT RUSH	5 GAL	L	3X3		48" o.c.	17
\bigodot	MUHLENBERGIA DUBIA PINE MUHLY	5 GAL	L	3X3		48" o.c.	8
	MUHLENBERGIA RIGENS DEER GRASS	5 GAL	L	5X5		66" o.c.	10
	OLEA EUROPAEA 'MONTRA' LITTLE OLLIE® OLIVE	5 GAL	L	5X5		48" o.c.	83
	WESTRINGIA FRUTICOSA 'NFL25' MUNDI™ COAST ROSEMARY	5 GAL	L	5X2		60" o.c.	117
GROUND CO	OVERS						
	DIANELLA TASMANICA 'VARIEGATA' VARIEGATED FLAX LILY	1 GAL	L	2X2		30" o.c.	80
	LOMANDRA LONGIFOLIA 'BREEZE' BREEZE™ MAT RUSH	1 GAL	L	3X3		36" o.c.	112
	SENECIO MANDRALISCAE	1 GAL	L	3X1		24" o.c.	67

PROJECT TEAM

LANDSCAPE ARCHITECT

EVERGREEN DESIGN GROUP
11801 PIERCE STREET, SUITE 200
RIVERSIDE, CA 92505
800-680-6630
WWW. EVERGREENDESIGNGROUP.COM
CONTACT: BLAKE TOMILLOSO-RHINEHART, PLA
EMAIL: BLAKE@EVERGREENDESIGNGROUP.COM

LANDSCAPE CALCULATIONS

GENERAL CALCULATIONS:
LANDSCAPE AREA PROVIDED:
PERIMETER LANDSCAPE PROVIDED:
INTERIOR LANDSCAPE PROVIDED:
TURF AREAS PROPOSED:

PARKING LOT LANDSCAPE:
PARKING STALL PROPOSED:

PARKING TREES REQUIRED:

0 SF (0% 7 STALLS 1 TREE (1 PER 6 STALLS)

2,051 SF (15.40%)

11,268 SF (84.60%)

13,319 SF

PARKING LOT SHADE:
PARKING LOT AREA:
1,295 SF
PARKING LOT SHADE REQUIRED:
259 SF (2
PARKING LOT SHADE PROVIDED:
1 TREE

259 SF (20%) 1 TREE W/ 30' CANOPY @ 50% = 481 SF

TOTAL SHADE = 481 SF

AFTER ALL PLANTING IS COMPLETE, CONTRACTOR SHALL INSTALL 3" THICK LAYER OF 1-1/2" SHREDDED WOOD MULCH, RECYCLED, NATURAL (UNDYED), OVER LANDSCAPE FABRIC IN ALL PLANTING AREAS (EXCEPT FOR TURF AND SEEDED AREAS). CONTRACTOR SHALL SUBMIT SAMPLES OF ALL MULCHES TO LANDSCAPE ARCHITECT AND OWNER FOR APPROVAL PRIOR TO CONSTRUCTION. ABSOLUTELY NO EXPOSED GROUND SHALL BE LEFT SHOWING ANYWHERE ON THE PROJECT AFTER MULCH HAS BEEN INSTALLED (SUBJECT TO THE CONDITIONS AND REQUIREMENTS OF THE "GENERAL GRADING AND PLANTING NOTES" AND SPECIFICATIONS).

ROOT BARRIERS

MULCHES

THE CONTRACTOR SHALL INSTALL ROOT BARRIERS NEAR ALL NEWLY-PLANTED TREES THAT ARE LOCATED WITHIN FIVE (5) FEET OF PAVING OR CURBS. ROOT BARRIERS SHALL BE "CENTURY" OR "DEEP-ROOT" 24" DEEP PANELS (OR EQUAL). BARRIERS SHALL BE LOCATED IMMEDIATELY ADJACENT TO HARDSCAPE. INSTALL PANELS PER MANUFACTURER'S RECOMMENDATIONS. UNDER NO CIRCUMSTANCES SHALL THE CONTRACTOR USE ROOT BARRIERS OF A TYPE THAT COMPLETELY ENCIRCLE THE ROOTBALL.

DECLARATION OF WATER EFFICIENT LANDSCAPE ORDINANCE I HAVE COMPLIED WITH THE CRITERIA OF THE WATER EFFICIENT LANDSCAPE ORDINANCE AND

APPLIED SUCH CRITERIA FOR THE EFFICIENT USE OF WATER IN THE LANDSCAPE DESIGN PLAN.

BLAKE TOMILLOSO-RHINEHART, LANDSCAPE ARCHITECT DATE

CA LICENSE #6255

REGISTRATION

EXP. DATE

EVERGREEN DESIGN GROUP 11801 PIERCE STREET, SUITE 200 RIVERSIDE, CA 92505

EXISTING PALM TREE -

TO BE REMOVED (TYP.)

EASEMENT

SIDEWALK -

BY OTHERS

PROPOSED POT AS

- EASEMENT

REFER TO POTTING

LEGEND

- HEADLIGHT SCRÉÉNING

36" TALL AT PLANTING

50% SHADE

COVERAGE = 481 SF

PROPOSED

BUILDING

- PROPOSED POT A1

LEGEND

HEADLIGHT SCREENING

36" TALL AT PLANTING

EXISTING PALM TREE?

TO BE REMOVED (TYP.)

PROPOSED POT A3,

REFER TO POTTING

TRASH ENCLOSURI

PROPOSED POT A1

SIDEWALK -

BY OTHERS

REFER TO POTTING

BY OTHERS

MWELO NOTES

- A DIAGRAM OF THE IRRIGATION PLAN SHOWING HYDROZONES SHALL BE KEPT WITH THE IRRIGATION CONTROLLER FOR SUBSEQUENT MANAGEMENT PURPOSES.
 A CERTIFICATE OF COMPLETION SHALL BE FILLED OUT AND CERTIFIED BY EITHER THE
- CONTRACTOR FOR THE PROJECT.

 3. AN IRRIGATION AUDIT REPORT BY A DISINTERESTED THIRD PARTY SHALL BE COMPLETED AT THE TIME OF FINAL INSPECTION

 4. THE CONTRACTOR SHALL PREPARE A SOILS MANAGEMENT REPORT. THE SOIL MANAGEMENT

REPORT SHALL BE BOTH INTEGRATED INTO THE PLANS AND SUBMITTED AS A SEPARATE

DESIGNER OF THE LANDSCAPE PLANS, IRRIGATION PLANS, OR THE LICENSED LANDSCAPE

- 5. PRESSURE REGULATING DEVICES ARE REQUIRED IF WATER PRESSURE IS BELOW OR EXCEEDS THE RECOMMENDED PRESSURE OF THE SPECIFIED IRRIGATION DEVICES.
- 6. CHECK VALVES OR ANTI-DRAIN VALVES ARE REQUIRED ON ALL SPRINKLER HEADS WHERE LOW POINT DRAINAGE COULD OCCUR.

SOILS NOTE

FOR SOILS LESS THAN 6% ORGANIC MATTER IN THE TOP 6 INCHES OF SOIL, COMPOST AT A RATE OF A MINIMUM OF FOUR CUBIC YARDS PER 1,000 SQUARE FEET OF PERMEABLE AREA SHALL BE INCORPORATED TO A DEPTH OF SIX INCHES INTO THE SOIL EXCEPT WITHIN THE TPZ OF PROTECTED TREES, WHICH SHALL RECEIVE 4 - 6" OF HARDWOOD CHIP MULCH.

POTTING LEGEND

POT A3 - DOWNTOWN ROUND (DCS-3600) - COLOR SHADOW - SANDBLAST FINISH - INSTALL W/ SELF-WATERING RESERVOIR (CWM-1714-3K) POT DIMENSIONS: 36"X22.5"X34"

(4) ALOE 'BLUE ELF' - 1 GAL


PLANT MATERIAL: INSTALL WITH PLANT MATERIAL PER PLANTING DIAGRAM BELOW


(1) ALOE 'HERCULES' - 15 GAL

(4) PORTULACARIA AFRA 'PROSTRATA' - 6" POT

POT A1 - DOWNTOWN ROUND (DCS-2400) - COLOR SHADOW - SANDBLAST FINISH - INSTALL W/
SELF-WATERING RESERVOIR (CWM-1114-2K)

POT DIMENSIONS: 24"X15.5"X27"
PLANT MATERIAL: INSTALL WITH PLANT MATERIAL PER PLANTING DIAGRAM BELOW
(1) AGAVE GEMINFLORA - 5 GAL
(4) SENECIO CEP. 'BLAZING GLORY' - 6" POT
(4) LYSIMACHIA NUMMULARIA - 6" POT

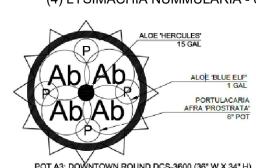

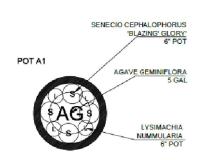

GENERAL GRADING AND PLANTING NOTES

- BY SUBMITTING A PROPOSAL FOR THE LANDSCAPE PLANTING SCOPE OF WORK, THE CONTRACTOR CONFIRMS THAT HE HAS READ, AND WILL COMPLY WITH, THE ASSOCIATED NOTES, SPECIFICATIONS, AND DETAILS WITH THIS PROJECT.

 THE GENERAL CONTRACTOR IS RESPONSIBLE FOR REMOVING ALL EXISTING VEGETATION (EXCEPT WHERE NOTED TO REMAIN).
- IN THE CONTEXT OF THESE PLANS, NOTES, AND SPECIFICATIONS, "FINISH GRADE" REFERS TO THE FINAL ELEVATION OF THE SOIL SURFACE (NOT TOP OF MULCH) AS INDICATED ON THE GRADING PLANS.

 3 REFORE STARTING WORK, THE LANDSCAPE CONTRACTOR SHALL VERIES THAT THE ROUGH GRADES OF ALL LANDSCAPE AREAS ARE WITHIN + /-0.11 OF FINISH GRADE. SEE SPECIFICATIONS FOR MORE DETAILED INSTRUCT
- a. BEFORE STARTING WORK, THE LANDSCAPE CONTRACTOR SHALL VERIFY THAT THE ROUGH GRADES OF ALL LANDSCAPE AREAS ARE WITHIN +/-0.1' OF FINISH GRADE. SEE SPECIFICATIONS FOR MORE DETAILED INSTRUCTION ON TURF AREA AND PLANTING BED PREPARATION.
 b. CONSTRUCT AND MAINTAIN FINISH GRADES AS SHOWN ON GRADING PLANS, AND CONSTRUCT AND MAINTAIN SLOPES AS RECOMMENDED BY THE GEOTECHNICAL REPORT. ALL LANDSCAPE AREAS SHALL HAVE POSITIVE DRAINAGE AWAY
- FROM STRUCTURES AT THE MINIMUM SLOPE SPECIFIED IN THE REPORT AND ON THE GRADING PLANS, AND AREAS OF POTENTIAL PONDING SHALL BE REGRADED TO BLEND IN WITH THE SURROUNDING GRADES AND ELIMINATE PONDING POTENTIAL.

 c. THE LANDSCAPE CONTRACTOR SHALL DETERMINE WHETHER OR NOT THE EXPORT OF ANY SOIL WILL BE NEEDED, TAKING INTO ACCOUNT THE ROUGH GRADE PROVIDED, THE AMOUNT OF SOIL AMENDMENTS TO BE ADDED (BASED ON A SOIL TEST, PER SPECIFICATIONS), AND THE FINISH GRADES TO BE ESTABLISHED.
- d. ENSURE THAT THE FINISH GRADE IN SHRUB AREAS IMMEDIATELY ADJACENT TO WALKS AND OTHER WALKING SURFACES, AFTER INSTALLING SOIL AMENDMENTS, IS 3" BELOW THE ADJACENT FINISH SURFACE, IN ORDER TO ALLOW FOR PROPER MULCH DEPTH. TAPER THE SOIL SURFACE TO MEET FINISH GRADE, AS SPECIFIED ON THE GRADING PLANS, AT APPROXIMATELY 18" AWAY FROM THE WALKS.

ENSURE THAT THE FINISH GRADE IN TURF AREAS IMMEDIATELY ADJACENT TO WALKS AND OTHER WALKING SURFACES, AFTER INSTALLING SOIL AMENDMENTS, IS 1" BELOW THE FINISH SURFACE OF THE WALKS. TAPER THE SOIL SURFACE

- TO MEET FINISH GRADE, AS SPECIFIED ON THE GRADING PLANS, AT APPROXIMATELY 18" AWAY FROM THE WALKS.

 f. SHOULD ANY CONFLICTS AND/OR DISCREPANCIES ARISE BETWEEN THE GRADING PLANS, GEOTECHNICAL REPORT, THESE NOTES AND PLANS, AND ACTUAL CONDITIONS, THE CONTRACTOR SHALL IMMEDIATELY BRING SUCH ITEMS TO THE
- ATTENTION OF THE LANDSCAPE ARCHITECT, GENERAL CONTRACTOR, AND OWNER.

 4. ALL PLANT LOCATIONS ARE DIAGRAMMATIC. ACTUAL LOCATIONS SHALL BE VERIFIED WITH THE LANDSCAPE ARCHITECT OR DESIGNER PRIOR TO PLANTING. THE LANDSCAPE CONTRACTOR SHALL ENSURE THAT ALL REQUIREMENTS OF THE
- PERMITTING AUTHORITY ARE MET (I.E., MINIMUM PLANT QUANTITIES, PLANTING METHODS, TREE PROTECTION METHODS, ETC.).

 a. THE LANDSCAPE CONTRACTOR IS RESPONSIBLE FOR DETERMINING PLANT QUANTITIES; PLANT QUANTITIES SHOWN ON LEGENDS AND CALLOUTS ARE FOR GENERAL INFORMATION ONLY. IN THE EVENT OF A DISCREPANCY BETWEEN THE PLAN AND THE PLANT LEGEND, THE PLANT QUANTITY AS SHOWN ON THE PLAN (FOR INDIVIDUAL SYMBOLS) OR CALLOUT (FOR GROUNDCOVER PATTERNS) SHALL TAKE PRECEDENCE.
- b. NO SUBSTITUTIONS OF PLANT MATERIALS SHALL BE ALLOWED WITHOUT THE WRITTEN PERMISSION OF THE LANDSCAPE ARCHITECT. IF SOME OF THE PLANTS ARE NOT AVAILABLE, THE LANDSCAPE CONTRACTOR SHALL NOTIFY THE LANDSCAPE ARCHITECT IN WRITING (VIA PROPER CHANNELS).
 c. THE CONTRACTOR SHALL, AT A MINIMUM, PROVIDE REPRESENTATIVE PHOTOS OF ALL PLANTS PROPOSED FOR THE PROJECT. THE CONTRACTOR SHALL ALLOW THE LANDSCAPE ARCHITECT AND THE OWNER/OWNER'S REPRESENTATIVE
- TO INSPECT, AND APPROVE OR REJECT, ALL PLANTS DELIVERED TO THE JOBSITE. REFER TO SPECIFICATIONS FOR ADDITIONAL REQUIREMENTS FOR SUBMITTALS.

 5. THE CONTRACTOR SHALL MAINTAIN THE LANDSCAPE IN A HEALTHY CONDITION FOR 90 DAYS AFTER ACCEPTANCE BY THE OWNER. REFER TO SPECIFICATIONS FOR CONDITIONS OF ACCEPTANCE FOR THE START OF THE MAINTENANCE PERIOD, AND FOR FINAL ACCEPTANCE AT THE END OF THE MAINTENANCE PERIOD.

 6. SEE SPECIFICATIONS AND DETAILS FOR FURTHER REQUIREMENTS.

IRRIGATION CONCEPT

- 1. AN AUTOMATIC IRRIGATION SYSTEM SHALL BE INSTALLED AND OPERATIONAL BY THE TIME OF FINAL INSPECTION. THE ENTIRE IRRIGATION SYSTEM SHALL BE INSTALLED BY A LICENSED AND QUALIFIED IRRIGATION CONTRACTOR.
 2. THE IRRIGATION SYSTEM WILL OPERATE ON POTABLE WATER, AND THE SYSTEM WILL HAVE APPROPRIATE BACKFLOW PREVENTION DEVICES INSTALLED TO PREVENT CONTAMINATION OF THE POTABLE SOURCE.
- 3. ALL NON-TURF PLANTED AREAS SHALL BE DRIP IRRIGATED. SODDED AND SEEDED AREAS SHALL BE IRRIGATED WITH SPRAY OR ROTOR HEADS AT 100% HEAD-TO-HEAD COVERAGE.

ROTOR AND SPRAY HEADS (WHEREVER POSSIBLE), RAIN SENSORS, AND MULTI-PROGRAM COMPUTERIZED IRRIGATION CONTROLLERS FEATURING SENSORY INPUT CAPABILITIES.

4. ALL PLANTS SHARING SIMILAR HYDROZONE CHARACTERISTICS SHALL BE PLACED ON A VALVE DEDICATED TO PROVIDE THE NECESSARY WATER REQUIREMENTS SPECIFIC TO THAT HYDROZONE.
5. THE IRRIGATION SYSTEM SHALL BE DESIGNED AND INSTALLED, TO THE MAXIMUM EXTENT POSSIBLE, TO CONSERVE WATER BY USING THE FOLLOWING DEVICES AND SYSTEMS: MATCHED PRECIPITATION RATE TECHNOLOGY ON



PRELIMINARY NOT FOR CONSTRUCTION



OUTDOOR TABLE

TABLE & BENCH PICNIC SET (Square)


Table Top / Seat Top: Recycled Plastic Lumber Support Frame: Powder Coated Mild Steel Bolt Down

Weather Resistant Materials for Outdoor Use *ADA Compliant with Open Side

BIKE RACK



ORMS+SURFACES® 30 Pine Street, Pittiburgh, PA 15223
Tel (800) 451-0410 Fax (412) 781-7840

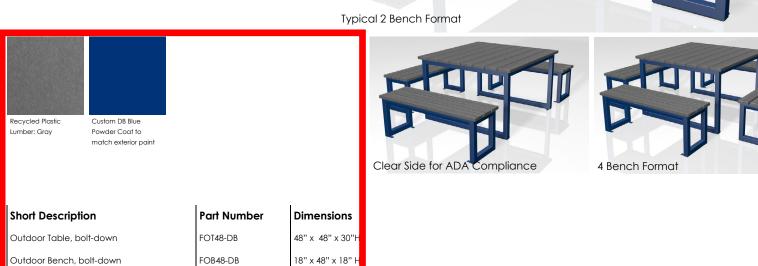


DUTCH BROS

Downtown Collection GFRC Round

Tournesol

 Lightweight GFRC concrete planters; durable despite low weight Coordinates with our self-watering container irrigation products Round planter sizes from 18" to 72"



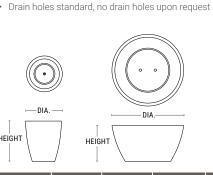

OLYMPIA" BIKE RACK

Position bike rack

PRODUCT	SHAPE	DIA.	HEIGHT	WEIGHT (LBS.)	VOLUME (CUBIC FT.)	INTERIOR TOP	INTERIOR BOTTOM	IRRIGATION
DCS-1800	Round	18" dia	18"	65	1.6	14.75" dia	12" dia	CWC-1300/CWM-1114-MS
DCS-2400	Round	24" dia	30"	125	3.2	15.5" dia	13.5" dia	CWC-1600/CWM-1114-2k
DCS-2418	Round	24" dia	18"	85	2.5	20" dia	12.5" dia	CWC-1600/CWM-1114-2k
DCS-3000	Round	30" dia	32"	185	6.7	26" dia	16.5" dia	CWC-2100/CWM-1714-2k
DCS-3600	Round	36" dia	34"	240	11	32" dia	21" dia	CWC-2500/CWM-1714-3k
DCS-3624	Round	36" dia	24"	160	8	32" dia	16" dia	CWM-1714-2k
DCS-3642	Round	36" dia	42"	305	17.7	32" dia	21" dia	CWC-2800/CWM 1720-3k
DCS-4200	Round	42" dia	36"	300	16	38" dia	25.5" dia	CWC-3300/CWM 1720-3k
DCS-4800	Round	48" dia	36"	360	26.5	44" dia	31.5" dia	CWM-1720-5k
DCS-4824	Round	48" dia	24"	245	16	44" dia	29.5" dia	CWM-2914-MS
DCS-6000	Round	60" dia	42"	515	28	56" dia	37" dia	CWM-2920-2k
DCS-6024	Round	60" dia	24"	355	28	56" dia	41.5" dia	CWM 2914-2k
DCS-7200	Round	72" dia	42"	645	69.4	68" dia	44" dia	CWM-2920-3k

SURFACE MOUNT INSTALLATION INSTRUCTIONS

page 2 of 3 | Rev. 12-14-21

SHADOW


GFRC LIGHTWEIGHT CONCRETE

Acid Etch

SURFACE MOUNT INSTALLATION INSTRUCTIONS





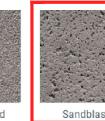

All Forms+Surfaces powdercoat colors have been formulated to be ultra-durable for improved long-term wear and resistance to weathering. Ou powdercoat colors are also anti-graffill, allowing marks from paint, permanent markers, and dirt to be easily removed. All standard powdercoat finishes are no-VOC.



SELF-WATERING RESERVOIR REFERENCE:

A-1, DOWNTOWN ROUND DCS-2400: CWM-1114-2K, WATERPROOF WITH TOURNESEAL A-3, DOWNTOWN ROUND DCS-3600: CWM-1714-3K, WATERPROOF WITH TOURNESEAL

ARMÉT DAVIS NEWLOVE & ASSOCIATES, AIA ARCHITECTS


1330 OLYMPIC BLVD.

THE USE OF THESE PLANS AND SPECIFICATIONS SHALL BE RESTRICTED TO THE ORIGINAL SITE FOR WHICH THEY WERE PREPARED AND PUBLICATION THEREOF IS EXPRESSLY LIMITED TO SUCH USE. RE—USE, REPRODUCTION OR PUBLICATION BY ANY METHOD, IN WHOLE OR IN PART, IS PROHIBITED. TITLE TO THE PLANS AND SPECIFICATIONS REMAINS WITH THE ARCHITECT WITHOUT PREJUDICE. VISUAL CONTACT WITH THESE PLANS AND SPECIFICATIONS SHALL CONSTITUTE PRIMA FACIE EVIDENCE OF THE ACCEPTANCE OF THE RESTRICTIONS.




SANTA MONICA, CALIFORNIA 90404 PH 310 452-5533 FAX 310 450-4742




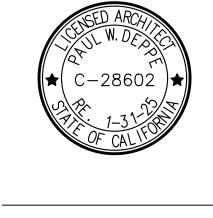

Stor

BIKE LOCKER (DOUBLE)

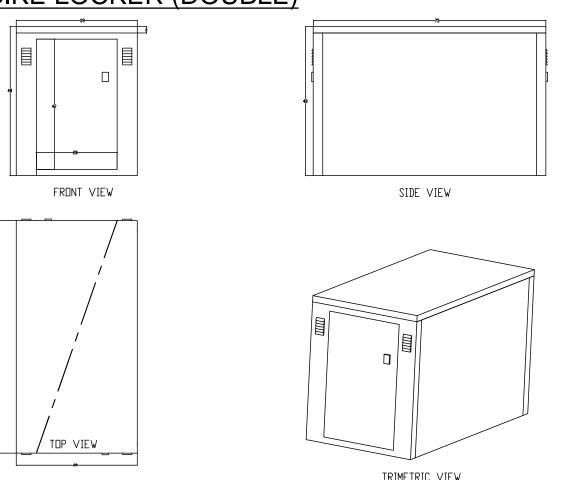


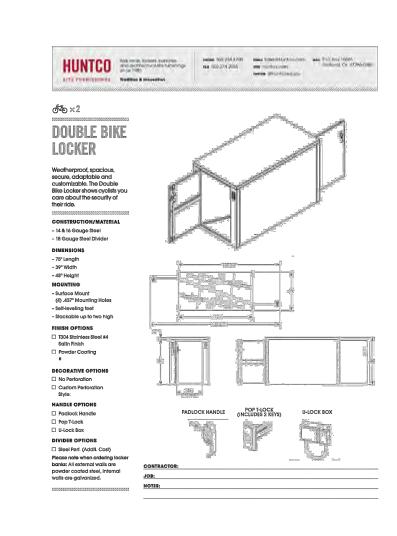


OLYMPIA" BIKE RACK

SURFACE MOUNT INSTALLATION INSTRUCTIONS

page 1 of 3 | Rev. 12-14-21

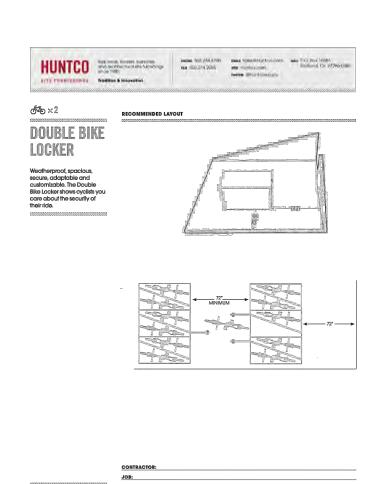

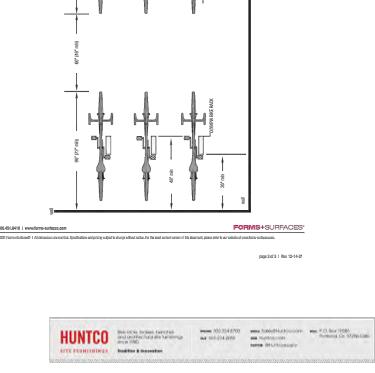

OLYMPIA" BIKE RACK




Colors may shift depending on monitor or printer capabilities. This is intended as a guide only.







TRASH RECEPTACLE

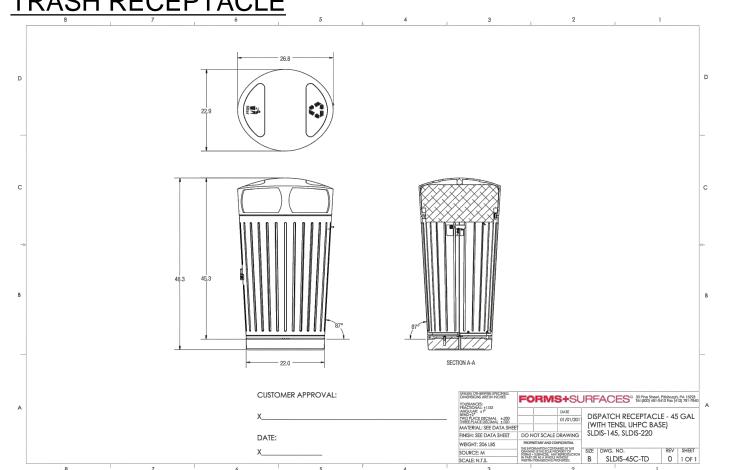

DISPATCH" RECEPTACLE

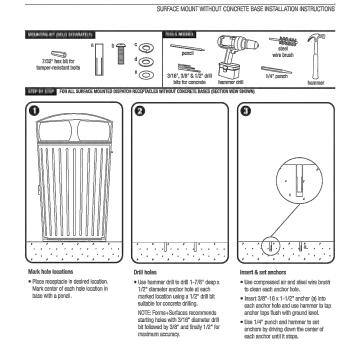


DISPATCH RECEPTACLE SURFACE MOUNT WITHOUT CONCRETE BASE INSTALLATION INSTRUCTIONS

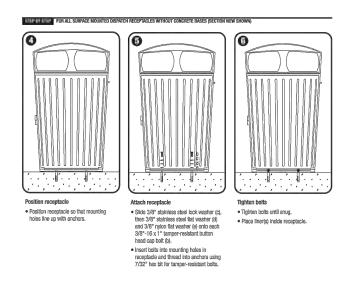

800.451.0410 www.forme-ourlaces.com	FORMS+SURFACI
2021 Forms+Surfaces® 1 All dimensions are numbers. Specifications and pricing subject to change will	thout notice. For the most current version of this document, please refer to our website at verse/forms-surfaces.com.
2021 Forms+Surfaces® 1 All dimensions are numinal. Specifications and pricing subject to change will	hout notice. For the most current version of this document, please refer to our website at verse/terms-surfaces.o


page 1 of 3 | Rev. 02-24-23



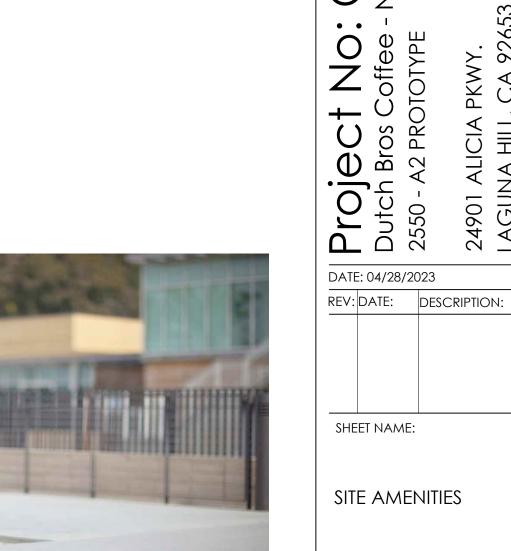

SHEET NAME: SITE AMENITIES

SHEET NUMBER: SA1.0

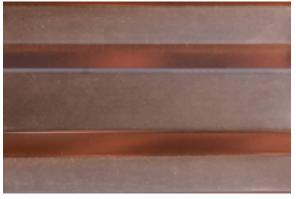

METAL PANEL AT TOWER WESTERN STATES METAL - WESTERN WAVE, 24 GA ORIENTATION: HORIZONTAL



COLOR: DUTCH BROS BLUE



EXTERIOR CEMENT PLASTER AT BUILDING SHERWIN WILLIAMS - SW6995 COLOR: SUPERWHITE




BRICK VENEER AT WAINSCOT & COLUMNS BELDEN BRICK COLOR: TITANIUM VELOUR



EXTERIOR CEMENT PLASTER AT BUILDING, CANOPY FASCIA & AWNINGS SHERWIN WILLIAMS - SW7069 COLOR: IRON ORE



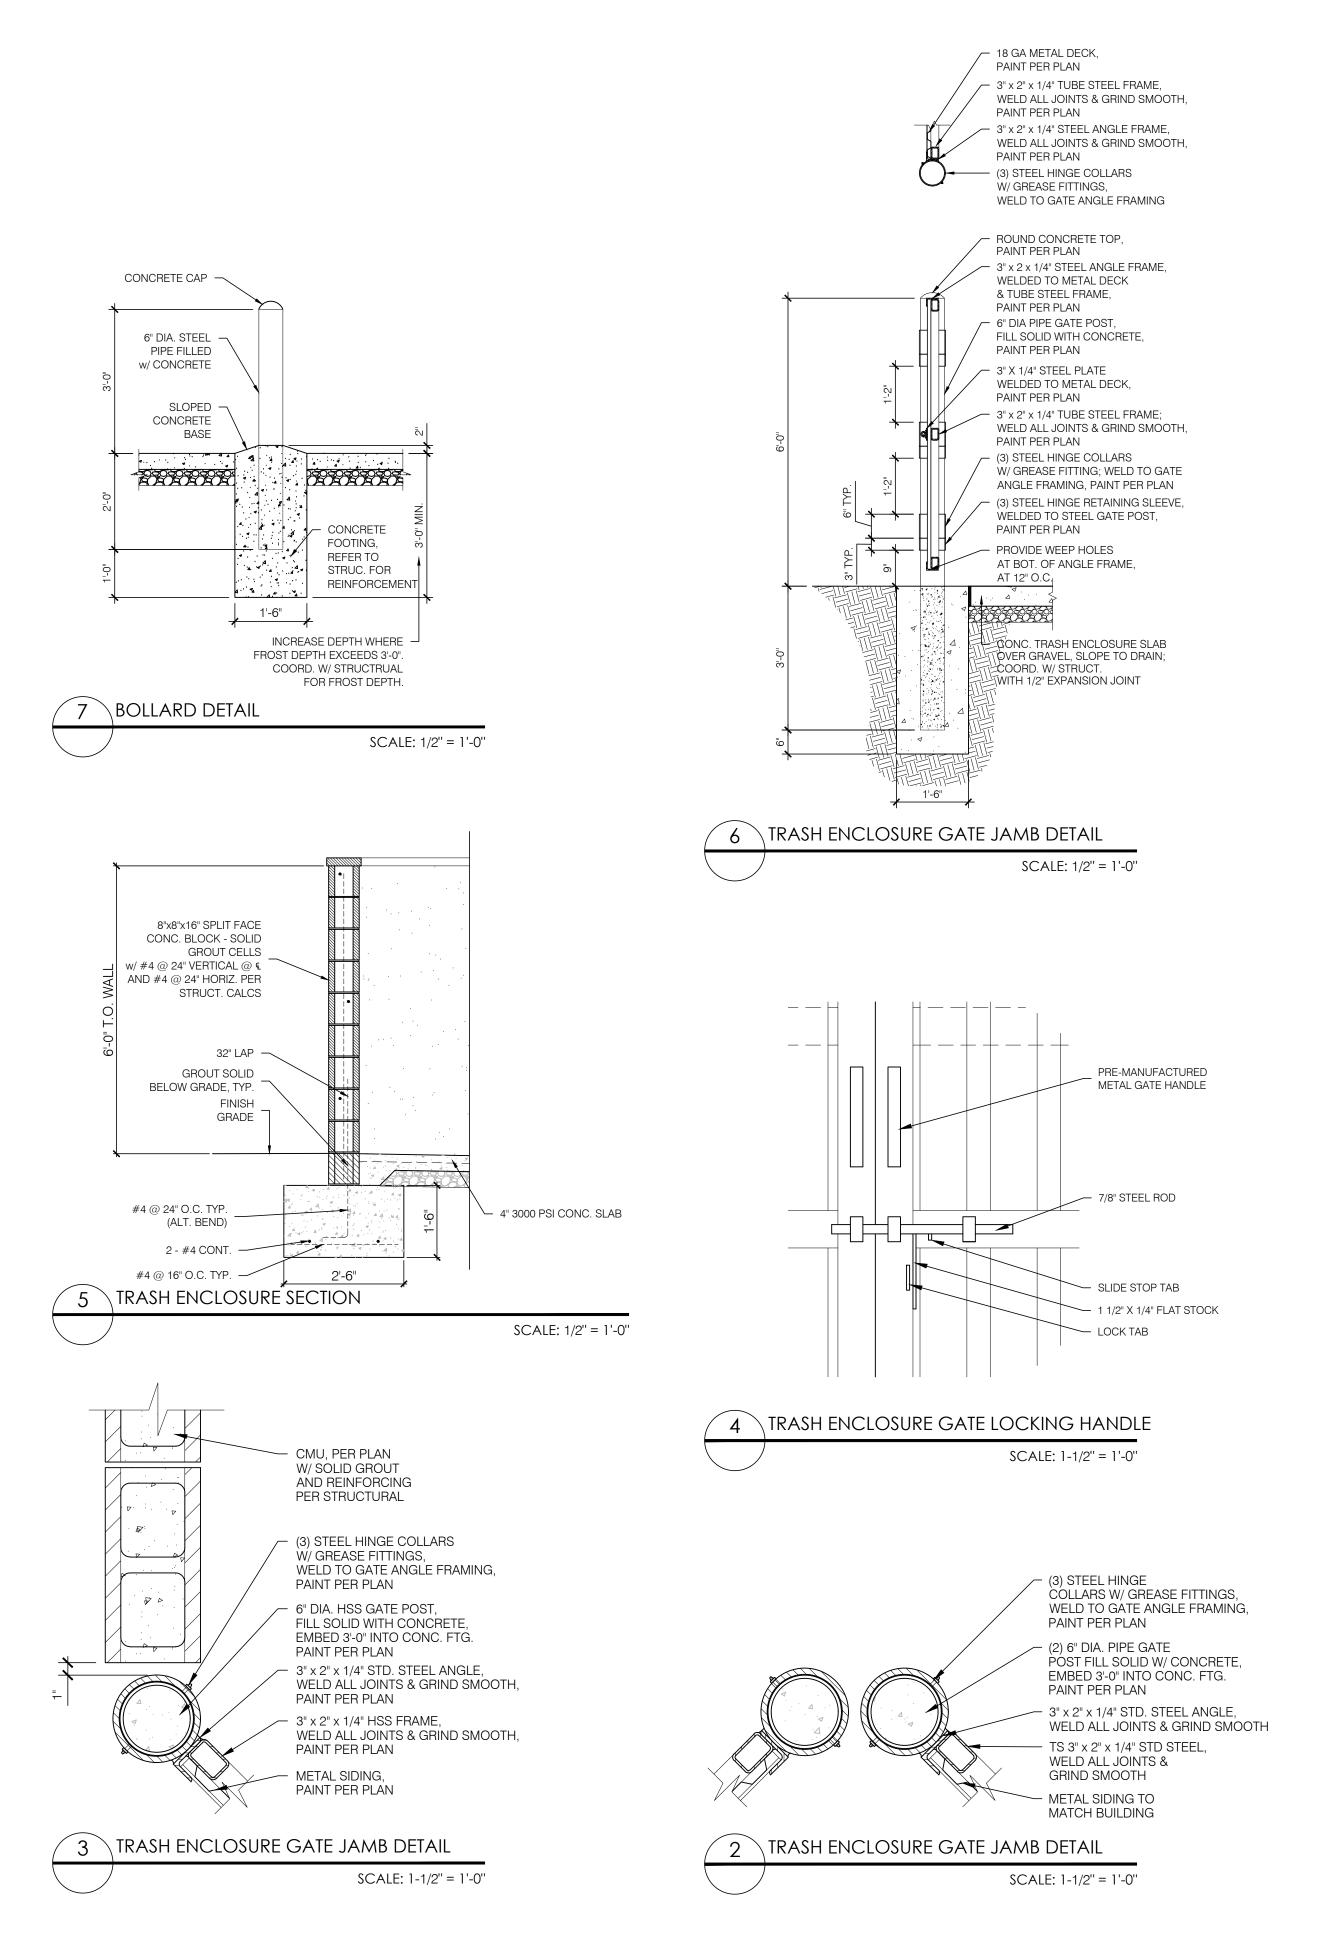

TRASH ENCLOSURE GENERAL NOTES:

\A9.0/

- 6" METAL BOLLARD -

DUMPSTER

BY REFUSE SERVICE

PROVIDER

10'-2" CLEAR

SLOPE: 1/8" PER FOOT,

TO AREA DRAIN

A9.0

PROVIDE METAL SLEEVES

IN CONC. APRON FOR GATE CANE ANCHORS, TYP.

FILLED W/ CONC.

YARD HYDRANT LOCATION, PROVIDE 3/4" WATER LINE,

3'-1" x 7'-2" PEDESTRIAN ACCESS GATE, W/ 4" HSS POSTS,

- 6"H x 6"W CONC. C<u>URB AT</u>

SIDES OF TRASH

ENCLOSURE, TYP.

SPLIT FACE, CMU WALLS

W/ 12"x16"x2"

PROVIDE METAL SLEEVES IN -

CONC. APRON FOR GATE

CANE ANCHORS, TYP.

CMU CAP

· (2) 5'-4" x 5'-8" STEEL GATES,

GATE POST,

CONC. FTG.

W/6" DIA. HSS

FILLED W/ CONC.;

EMBED 36" INTO

- PROVIDE METAL SLEEVES

GATE CANE ANCHORS, TYP.

IN CONC. APRON FOR

1'-6" TYP.

FILLED W/ CONC.
EMBED 36" INTO

COORD. W/ PLUMBING

(3) (A9.1)

(A9.0)

ROOF OVERHANG

1. REFER TO STRUCTURAL FOR MASONRY, CONCRETE, STRUCTURAL STEEL AND REINFORCING STEEL FOR SPECIFICATIONS.

ROOF POST WELDED

U-SHAPED SADDLE, TYP. OF 3

— 4" THICK, 3000 P.S.I.

AREA DRAIN

SLOPE: 1/8" PER FOOT,

TO AREA DRAIN

- ROOF POST WELDED TO BASE

PLATE AND FASTENED TO SLAB 10'-2" CLEAR

PROVIDE METAL SLEEVES IN —

CANE ANCHORS, TYP.

CONC. APRON FOR GATE

CONCRETE SLAB WITH

6x6-W1.4x1.4 STL. MESH

- 4" THICK, 3000 P.S.I. — CONCRETE SLAB

TRASH ENCLOSURE PLAN

WITH 6x6-W1.4x1.4 STL. MESH

ROOF POST WELDED -

TYP. OF 2

ROOF

OVERHANG

4 A9.1

L-SHAPED SADDLE,

8"x16"x8" SPLIT FACE

W/ 12"x16"x2" CMU CAP

— 6" METAL BOLLARD —

FILLED W/ CONC.

DUMPSTER

BY REFUSE SERVICE

PROVIDER

CMU WALLS

6"H x 6"W CONC. CURB -

AT SIDES OF TRASH

(2) 5'-4" x 5'-8" STEEL GATES, -

FILLED W/ CONC.

EMBED 36" INTO

CONC. FTG.

W/ 6" DIA. HSS GATE POST,

SCALE: 1/2" = 1'-0"

-- ¡ENCLOSURE, TYP.

- 2. PROVIDE LOCKING MECHANISM ON MAIN DOORS AND PEDESTRIAN DOOR
- 3. PROVIDE SITE LIGHTING AT TRASH ENCLOSURE. MIN. 5 FOOT CANDLE.
- 4. GATE TO BE BUILT WITH 3"X2" SQUARE STEEL TUBING WITH ALL JOINTS FULLY WELDED TOGETHER AND 1 CROSS MEMBER PER GATE. FRAME TO BE PRIMED AND PAINTED PER PLAN..
- 5. REFER TO STRUCTURAL DRAWINGS FOR SPECIFICATIONS (GENERAL NOTES) AND TYPICAL DETAILS FOR MASONRY, CONCRETE, STRUCTURAL STEEL AND REINFORCING STEEL.





ASSOCIATES, AIA ARCHITECTS 1330 OLYMPIC BLVD.

SANTA MONICA, CALIFORNIA 90404

PH 310 452-5533 FAX 310 450-4742

THE USE OF THESE PLANS AND SPECIFICATIONS SHALL BE RESTRICTED TO THE ORIGINAL SITE FOR WHICH THEY WERE PREPARED AND PUBLICATION THEREOF IS EXPRESSLY LIMITED TO SUCH USE. RE-USE, REPRODUCTION OR PUBLICATION BY ANY METHOD, IN WHOLE OR IN PART, IS PROHIBITED, TITLE TO THE PLANS AND SPECIFICATIONS REMAINS WITH THE ARCHITECT WITHOUT PREJUDICE. VISUAL CONTACT WITH THESE PLANS AND SPECIFICATIONS SHALL CONSTITUTE PRIMA FACIE EVIDENCE OF THE ACCEPTANCE OF THE RESTRICTIONS.



SŦ 0

DATE: 04/28/2023 REV: DATE: DESCRIPTION:

SHEET NAME:

TRASH ENCLOSURE PLAN & DETAILS

SHEET NUMBER:

TRAS	H ENCLOSUF	RE MATERIALS		
ID	MATERIAL	MANUFACTURER	COLOR	NOTES
3	SPLIT FACE 8X8X16	BASALITE	CHARCOAL	IF INTEGRAL COLOR BLOCK IS UNAVAILABLE, BLOCK TO BE STAINED TO MATCH SW0769 IRON ORE
	CMU CAP	BASALITE	CHARCOAL	12X16X2
PT-2	PAINT	SHERWIN-WILLIAMS	SW0769 IRON ORE	GATES BODY, ROOF, ROOF BEAMS & COLUMNS
PT-3	PAINT	SHERWIN-WILLIAMS	8656-12045 - BLDG DB BLUE	BLDG DB BLUE, GATE FRAMES & POSTS

TRASH ENCLOSURE GENERAL NOTES:

- 1. REFER TO STRUCTURAL FOR MASONRY, CONCRETE, STRUCTURAL STEEL AND REINFORCING STEEL FOR SPECIFICATIONS.
- 2. PROVIDE LOCKING MECHANISM ON MAIN DOORS AND PEDESTRIAN DOOR
- 3. PROVIDE SITE LIGHTING AT TRASH ENCLOSURE. MIN. 5 FOOT CANDLE.
- 4. GATE TO BE BUILT WITH 3"X2" SQUARE STEEL TUBING WITH ALL JOINTS FULLY WELDED TOGETHER AND 1 CROSS MEMBER PER GATE. FRAME TO BE PRIMED AND PAINTED PER PLAN..
- 5. REFER TO STRUCTURAL DRAWINGS FOR SPECIFICATIONS (GENERAL NOTES) AND TYPICAL DETAILS FOR MASONRY, CONCRETE, STRUCTURAL STEEL AND REINFORCING STEEL.

SLOPE: 1/4" PER FOOT






ARMÉT DAVIS NEWLOVE & **ASSOCIATES, AIA ARCHITECTS**

> 1330 OLYMPIC BLVD. SANTA MONICA, CALIFORNIA 90404 PH 310 452-5533 FAX 310 450-4742

THE USE OF THESE PLANS AND SPECIFICATIONS SHALL BE RESTRICTED TO THE ORIGINAL SITE FOR WHICH THEY WERE PREPARED AND PUBLICATION THEREOF IS EXPRESSLY LIMITED TO SUCH USE. RE-USE, REPRODUCTION OR PUBLICATION BY ANY METHOD, IN WHOLE OR IN PART, IS PROHIBITED. TITLE TO THE PLANS AND SPECIFICATIONS REMAINS WITH THE ARCHITECT WITHOUT PREJUDICE. VISUAL CONTACT WITH THESE PLANS AND SPECIFICATIONS SHALL CONSTITUTE PRIMA FACIE EVIDENCE OF THE ACCEPTANCE OF THE RESTRICTIONS.

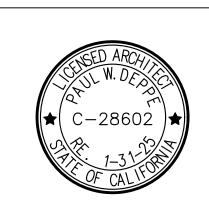

6" TYP.
OVERHANG

SCALE: 1/2" = 1'-0"



Stor $\sqrt{7101}$ Project No: Dutch Bros Coffee -2550 - A2 PROTOTYPE

DATE: 04/28/2023 REV: DATE: DESCRIPTION:


SHEET NAME:


TRASH ENCLOSURE **ELEVATIONS &** DETAILS


SHEET NUMBER:


© 2019 DB Franchising USA, LLC

TRASH ENCLOSURE FRONT ELEVATION

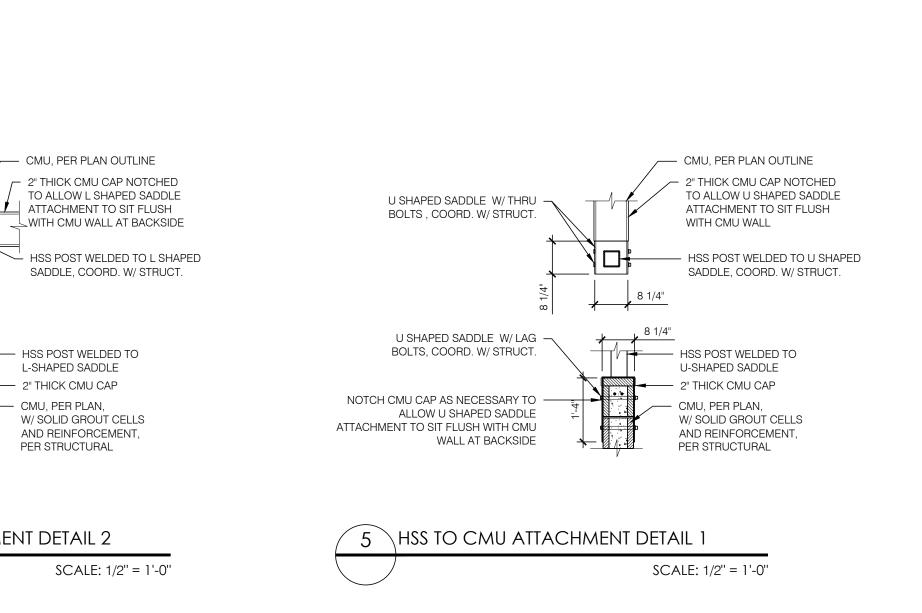

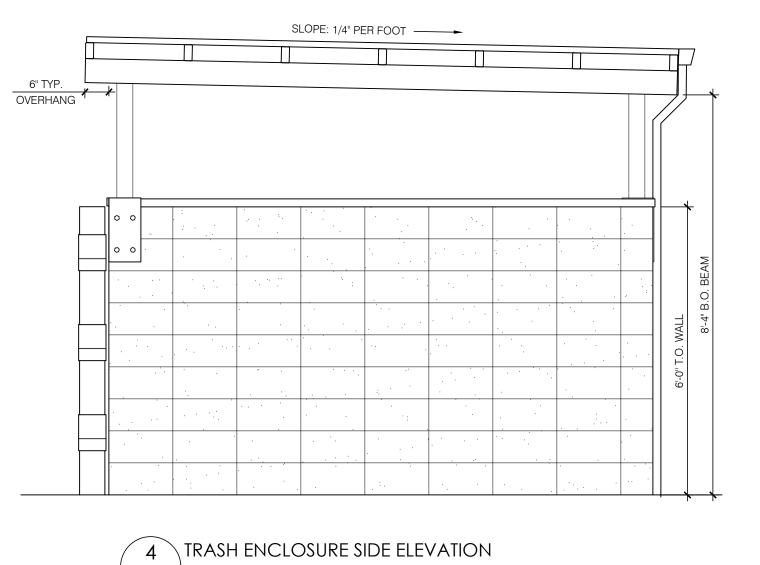

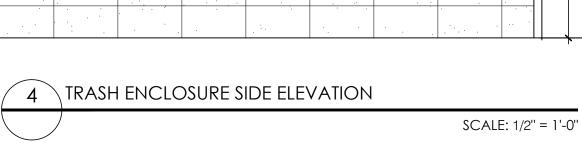


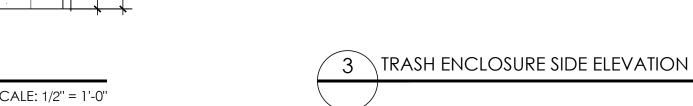

6" GUTTER TO 3"x2" SMOOTH RECTILINEAR DOWNSPOUT,

PAINT PER PLAN

DAYLIGHT TO NEAREST LANDSCAPE;

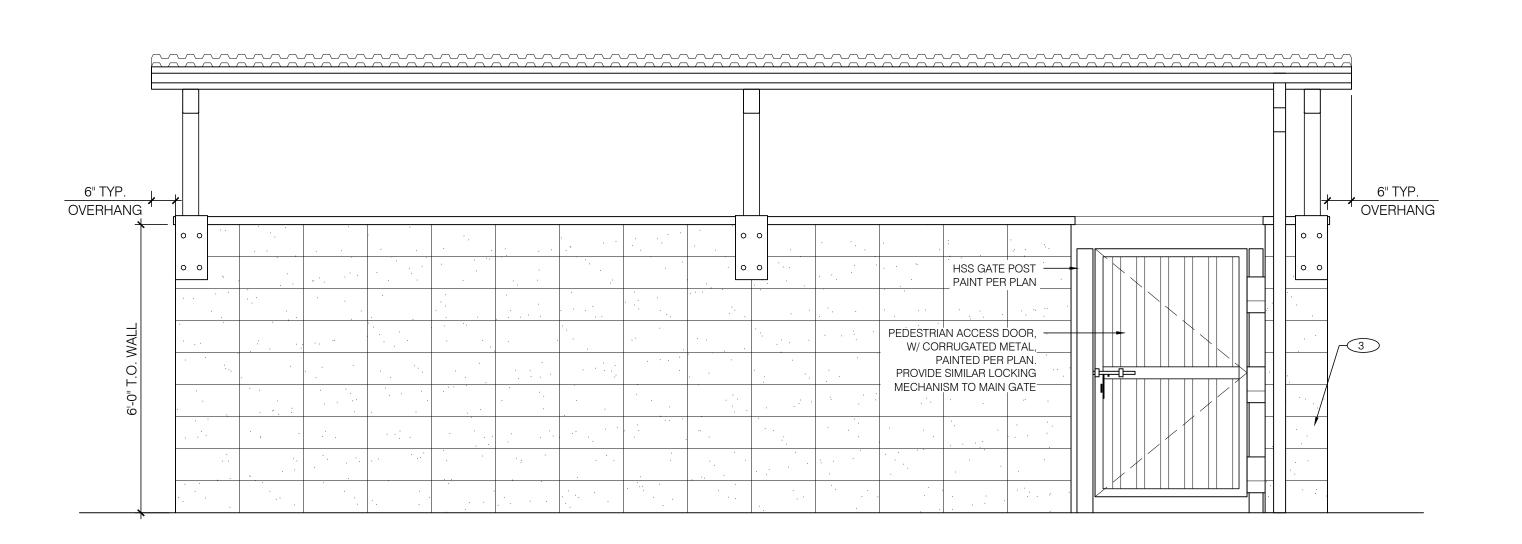

L SHAPED SADDLE W/ LAG -

BOLTS EMBEDDED IN THE

GROUT FILLED CMU WAL,

L SHAPED SADDLE W/ LAG -

BOLTS EMBEDDED IN THE

GROUT FILLED CMU WAL,

ALLOW L SHAPED SADDLE

NOTCH CMU CAP AS NECESSARY TO

ATTACHMENT TO SIT FLUSH WITH CMU

COORD. W/ STRUCT.

WALL AT BACKSIDE


6 HSS TO CMU ATTACHMENT DETAIL 2


L-SHAPED SADDLE

CMU, PER PLAN,


2" THICK CMU CAP

COORD. W/ STRUCT.

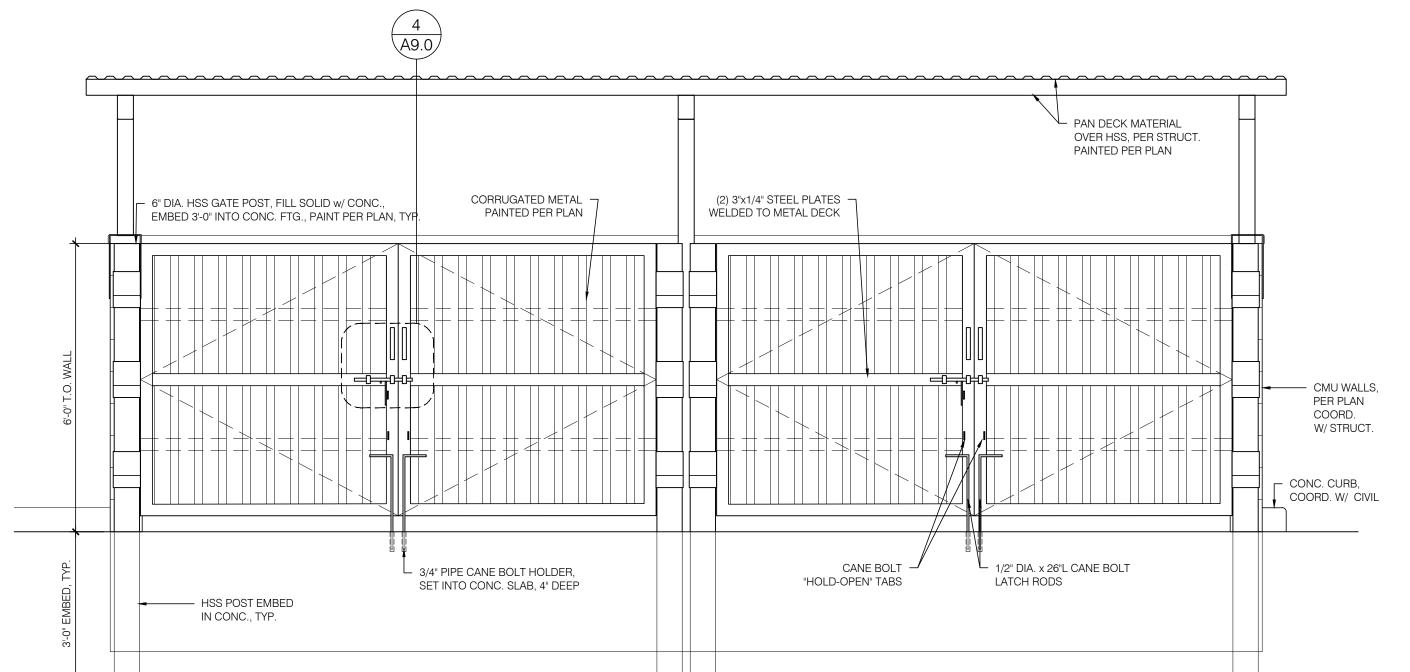

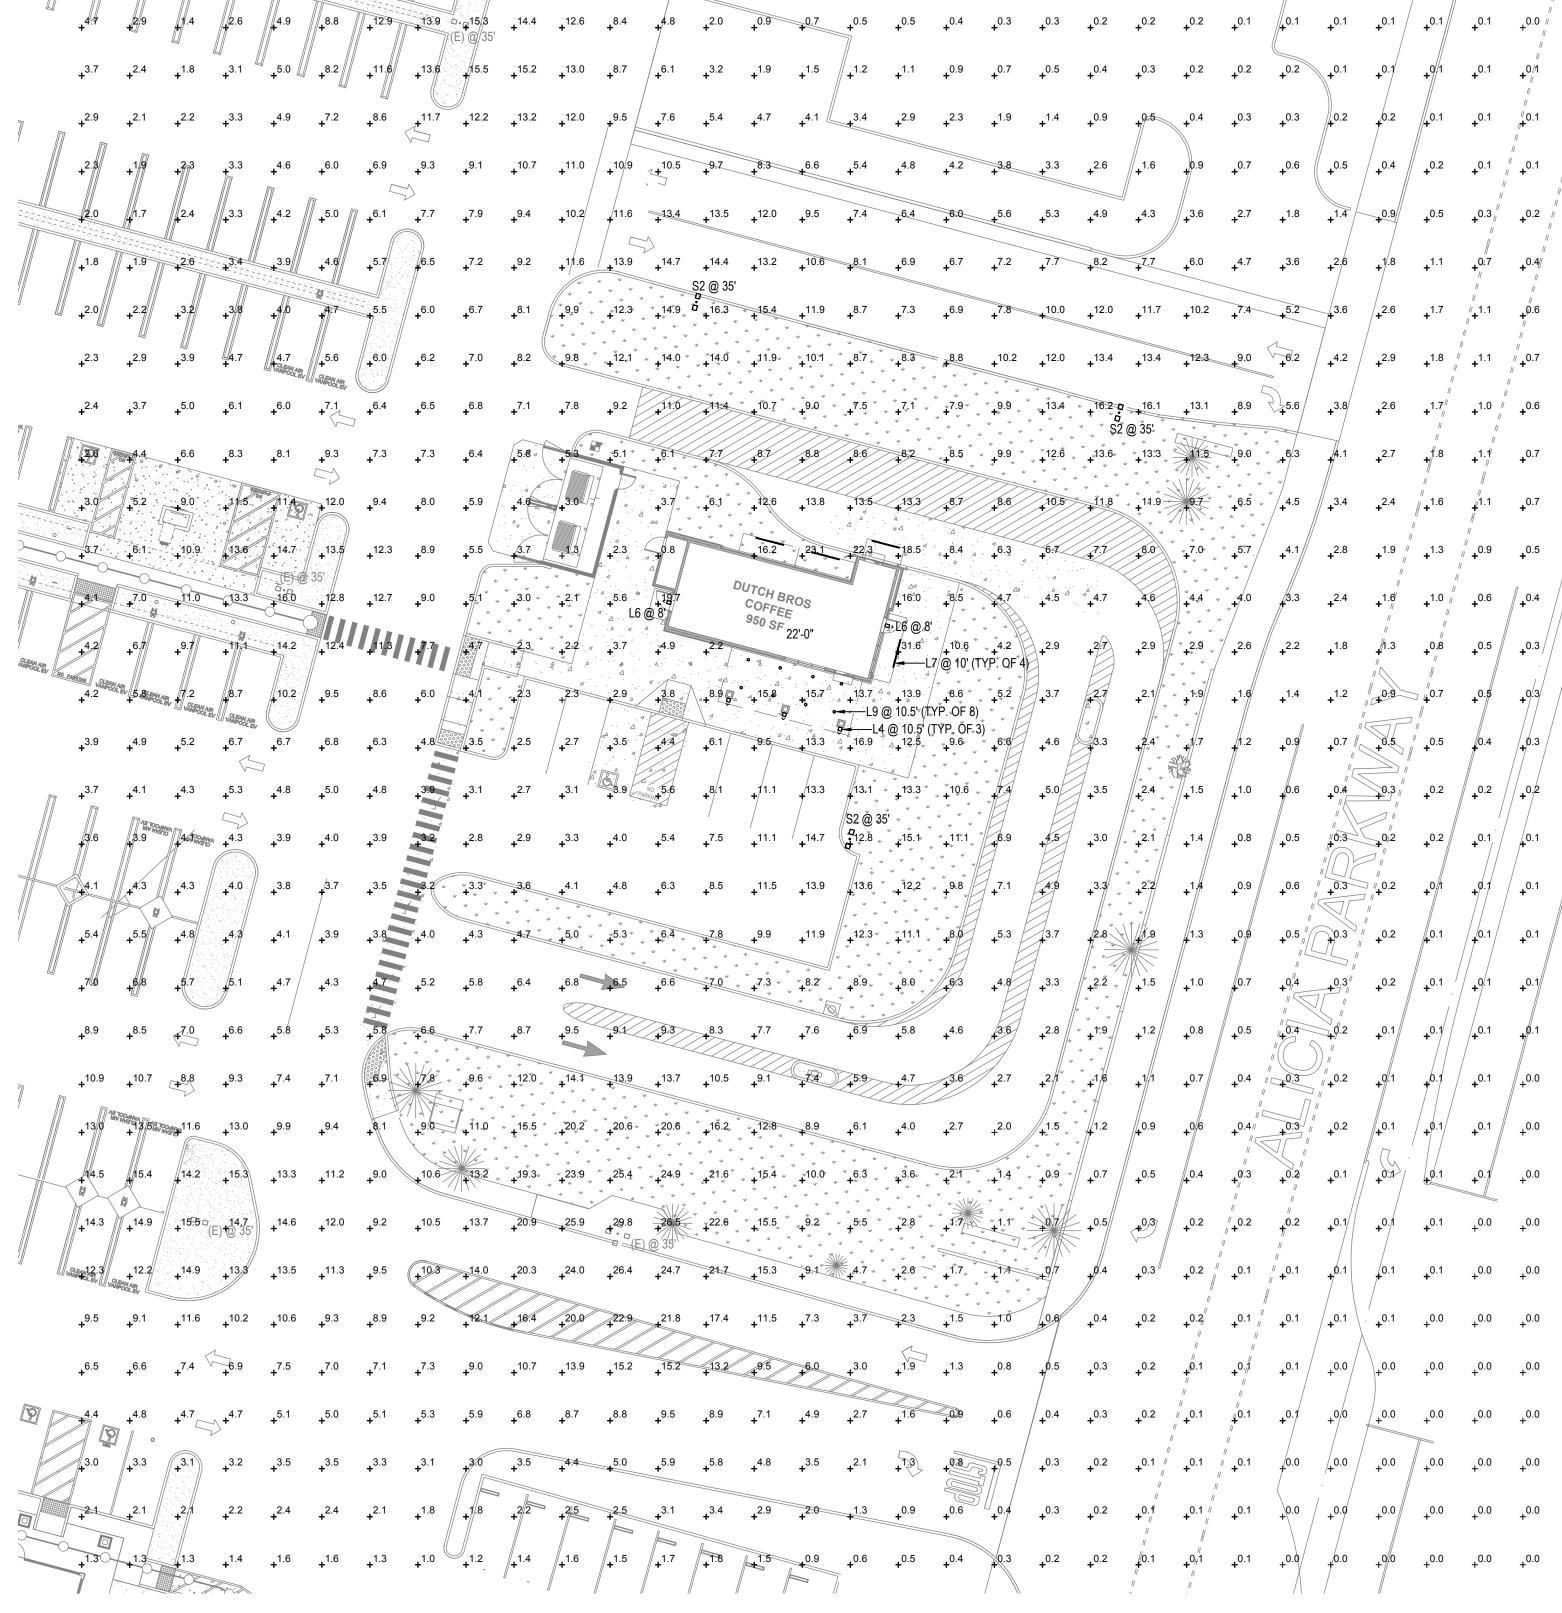

SCALE: 1" = 20'-0"

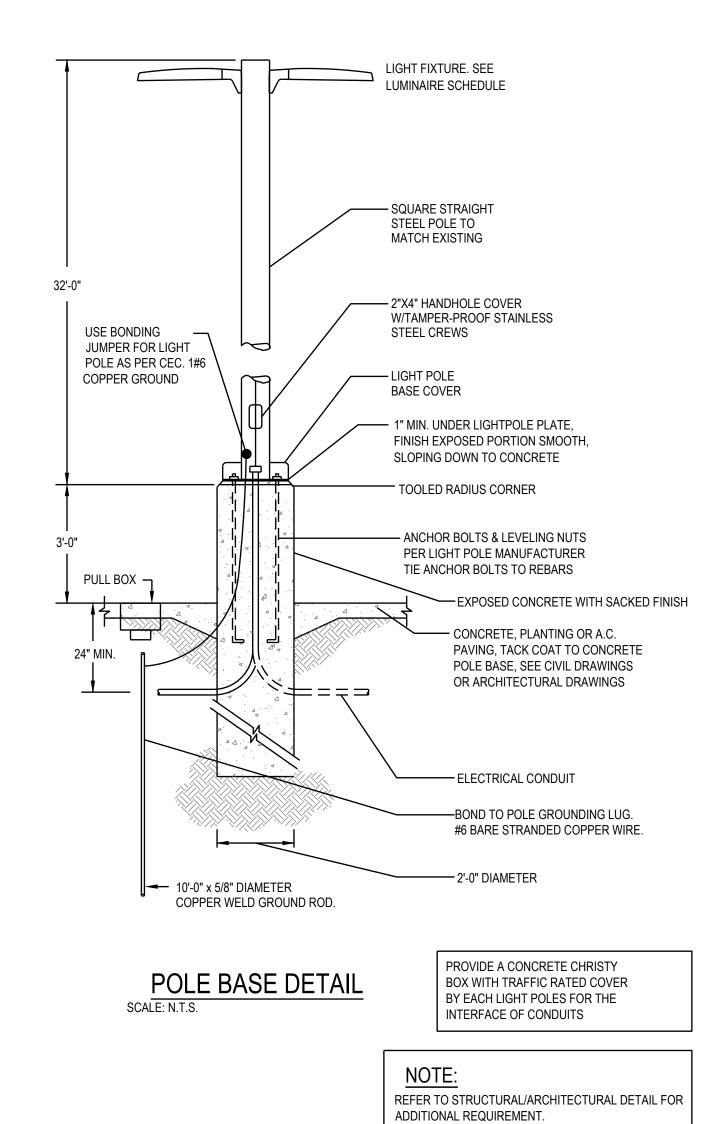

DESCRIPTION DRIVE THRU	SYMBOL +	AVE 6.5 fc	MAX 18.5 fc	MIN 2.0 fc	9.3:1	AVE/N 3.3
GENERAL HARDSCAPE	+	8.3 fc	31.6 fc	0.7 fc	45.1:1	11.9
PARKING SPACES	+	6.7 fc	14.7 fc	2.3 fc	6.4:1	2.9
TRASH ENCLOSURE	+	2.1 fc	3.0 fc	1.3 fc	2.3:1	1.6

SCHEDU	ILE								
SYMBOL	LABEL	QUANTITY	MANUFACTURER	CATALOG NUMBER UNDER CANOPY OR BUG RATING	DESCRIPTION	NUMBER OF LAMPS	LUMENS PER LAMP	LIGHT LOSS FACTOR	WATTAGE
â	L4	3	LIGMAN	UMT-31416-DBNA-14/14W-N-W40 (UNDER CANOPY)	MATRIX 3 TWO SIDE SQUARE WALL LUMINAIRE	2	1100	0.92	28.60
ô	L6	2	RAB LIGHTING INC.	WPLED26Y-WPLED26Y/D10 (WALLPACK) - ALED26Y-ALED26Y/D10 (AREA LIGHTER) (UNDER CANOPY)	CAST FINNED METAL HOUSING, MOLDED PLASTIC REFLECTOR WITH SEMI-SPECULAR FINISH B1-U0-G1	1	3295	0.92	29.70
	L7	4	SELF	CROWN-L144-120V 840_BA110 (UNDER CANOPY)	CROWN-L144-120V 840_BA110	1	6300	0.92	60
0	L9	8	DMF LIGHTING	DRD5S-4R-07930 (UNDER CANOPY)	DRD5S-4R-07930	1	757	0.92	8.37
-	(E)	-	LITHONIA LIGHTING	RSX4 LED P1 40K AFR (EXISTING LIGHT POLE)	RSX AREA LUMINAIRE SIZE 4 P1 LUMEN PACKAGE 4000K CCT TYPE AFR DISTRIBUTION	1	39804	0.92	550
	(E)	-	LITHONIA LIGHTING	RSX4 LED P1 40K AFR (EXISTING LIGHT POLE)	RSX AREA LUMINAIRE SIZE 4 P1 LUMEN PACKAGE 4000K CCT TYPE AFR DISTRIBUTION	1	39804	0.92	1100
- • -	S2	3	LITHONIA LIGHTING	RSX4 LED P1 40K AFR (BUG RATING:B3 - U0 - G3)	RSX AREA LUMINAIRE SIZE 4 P1 LUMEN PACKAGE 4000K CCT TYPE AFR DISTRIBUTION	1	39804	0.92	550



ARMÉT DAVIS NEWLOVE & **ASSOCIATES, AIA ARCHITECTS**

> 1330 OLYMPIC BLVD. SANTA MONICA, CALIFORNIA 90404 PH 310 452-5533 FAX 310 450-4742

THE USE OF THESE PLANS AND SPECIFICATIONS SHALL BE RESTRICTED TO THE ORIGINAL SITE FOR WHICH THEY WERE PREPARED AND PUBLICATION THEREOF IS EXPRESSLY LIMITED TO SUCH USE. RE-USE, REPRODUCTION OR PUBLICATION BY ANY METHOD, IN WHOLE OR IN PART, IS PROHIBITED. TITLE TO THE PLANS AND SPECIFICATIONS REMAINS WITH THE ARCHITECT WITHOUT PREJUDICE. VISUAL CONTACT WITH THESE PLANS AND SPECIFICATIONS SHALL CONSTITUTE PRIMA FACIE EVIDENCE OF THE ACCEPTANCE OF THE RESTRICTIONS.

ACIES ENGINEERING 400 N. McCarthy Blvd., Suite 250 Milpitas CA, 95035 ph: (408)522-5255 | fx: (408)522-5260 info@acies.net | Copyright ② 2023





estanding Store 10 Project No: Dutch Bros Coffee - Dutch Bros Cof

DATE: 04/28/2023 REV: DATE: DESCRIPTION:

PHOTOMETRIC SITE PLAN

SHEET NUMBER: E0.02

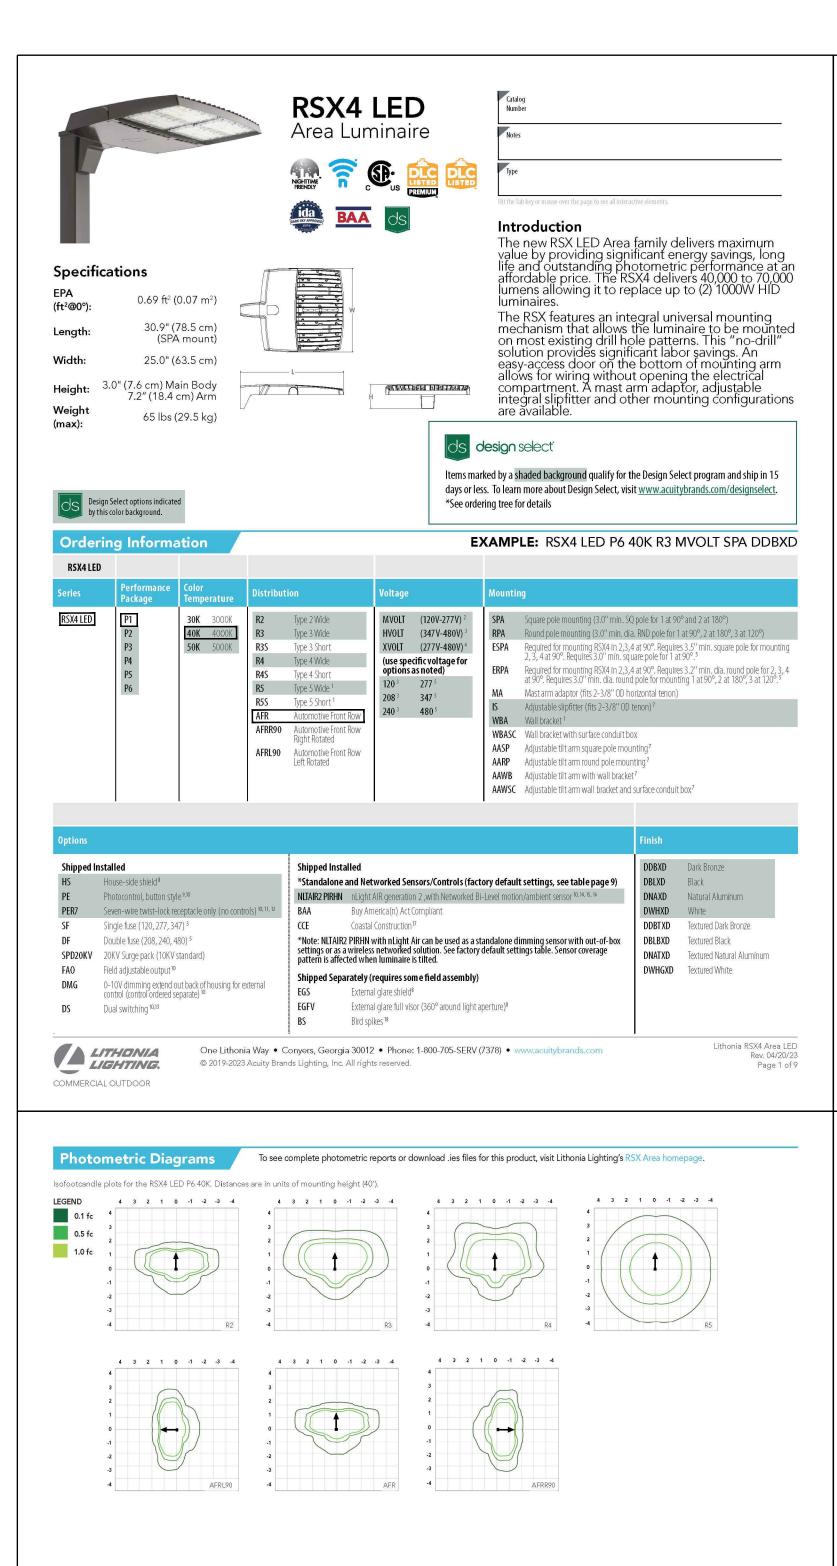

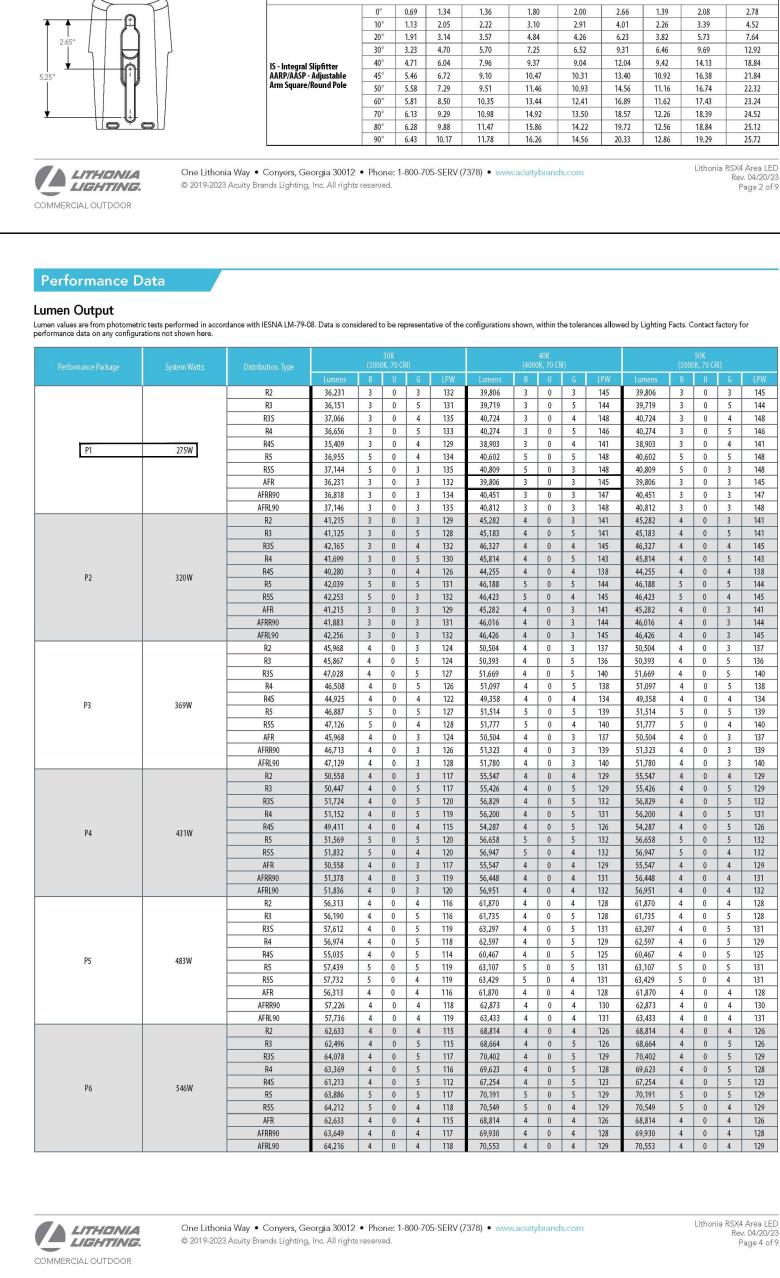

Ordering Information

RSX4EGS (FINISH) U External glare shield (specify finish)

RSX4EGFV (FINISH) U External glare full visor (specify finish)

RSXWBA (FINISH) U RSX WBA wall bracket (specify finish) 1

DLL127F 1.5 JU Photocell -SSL twist-lock (120-277V) 19 DLL347F 1.5 CUL JU Photocell -SSL twist-lock (347V) 19

DLL480F 1.5 CUL JU Photocell -SSL twist-lock (480V) 19

External Shields

DSHORT SBK U Shorting cap 19

RSXRPA (FINISH) U RSX Universal round pole adaptor plate (specify finish)

Pole/Mounting Informatiion

HANDHOLE ORIENTATION

RSX POLE DRILLING

RSX STANDARD ARM

EXTENDED ARM AND ADJUSTÁBLE ARM

Template #8 Top of Pole


at Lithonia's Outdoor Poles and Arms product page. Click here to visit Accessories

Accessories

RSXSCB (FINISH) U RSX Surface conduit box (specify finish, for use with WBA, WBA not included)

RSX4 House side shields for AFR rotated optics (includes 4 shields)

RSX4 House side shield (includes 4 shields)

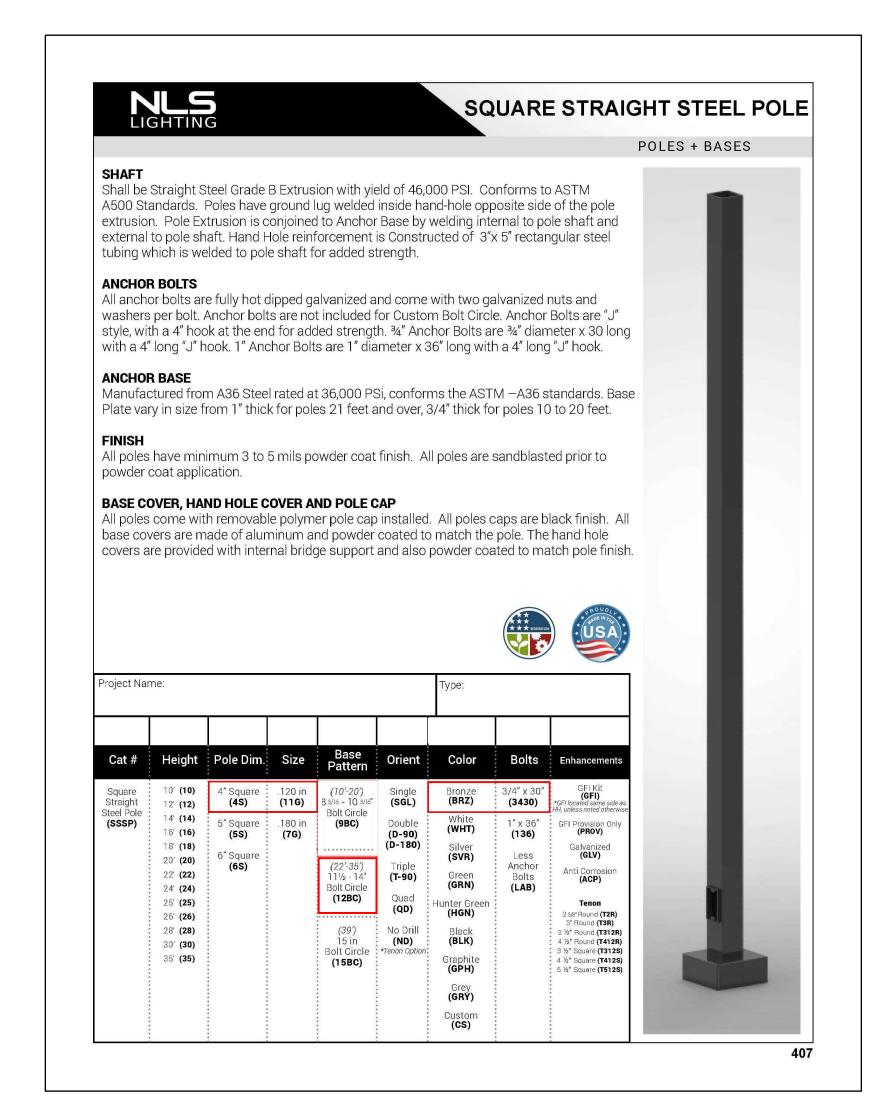



ARMÉT DAVIS NEWLOVE & ASSOCIATES, AIA ARCHITECTS

> 1330 OLYMPIC BLVD. SANTA MONICA, CALIFORNIA 90404 PH 310 452-5533 FAX 310 450-4742

THE USE OF THESE PLANS AND SPECIFICATIONS SHALL BI RESTRICTED TO THE ORIGINAL SITE FOR WHICH THEY WERE PREPARED AND PUBLICATION THEREOF IS EXPRESSLY LIMITED TO SUCH USE. RE-USE, REPRODUCTION OR PUBLICATION BY ANY METHOD, IN WHOLE OR IN PART, IS PROHIBITED. TITLE TO THE PLANS AND SPECIFICATIONS REMAINS WITH THE ARCHITECT WITHOUT PREJUDICE. VISUAL CONTACT WITH THESE PLANS AND SPECIFICATIONS SHALL CONSTITUTE PRIMA FACIE EVIDENCE OF THE ACCEPTANCE OF THE RESTRICTIONS.

> **ACIES** ENGINEERING 400 N. McCarthy Blvd., Suite 250 Milpitas CA, 95035 ph: (408)522-5255 | fx: (408)522-5260 info@acies.net | Copyright © 2023



0 Project No: Dutch Bros Coffee -2550 - A2 PROTOTYPE

Stor

DATE: 04/28/2023

REV: DATE: DESCRIPTION:


SHEET NAME:

EXTERIOR LIGHTING CUTSHEETS

SHEET NUMBER:

© 2019 DB Franchising USA, LLC



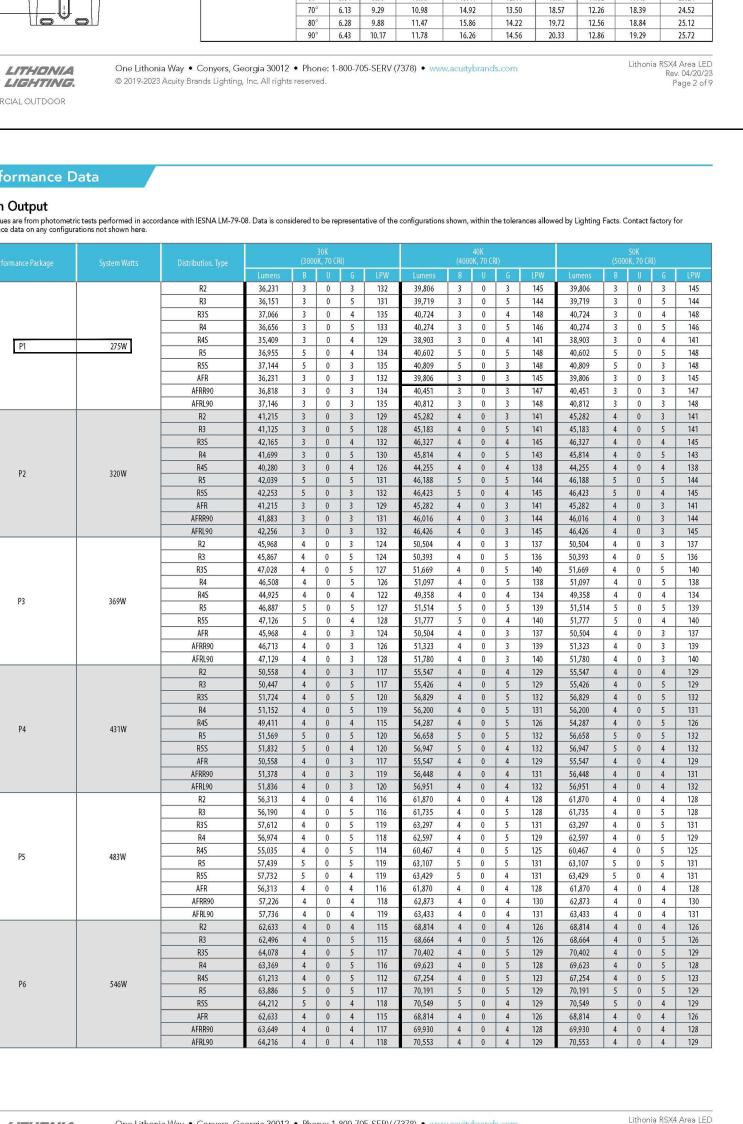

Any Type 5 distribution, is not available with WBA.
MVOLT driver operates on any line voltage from 120-277V (50/60 Hz).
HVOLT driver operates on any line voltage from 347-480V (50/60 Hz).
XVOLT driver operates on any line voltage from 277V-480V (50/60 Hz).
XVOLT not available with fusing (SF or DF) and not available with PE or PEX.

Single fuse (SF) requires 120V, 277V or 347V. Double fuse (DF) requires 208V, 240V or 480V.

Maximum tilt is 90° above horizontal.

External Glare Shield (EGS)

Accessories including bullhorns, cross arms and other adpaters are available on pages 5-8. For the complete line of accessories available, visit the accessories tab

2 - 3/8" RPA, ERPA, AARP AS3-5 190 AS3-5 280 AS3-5 290 AS3-5 320 AS3-5 390 AS3-5 490

2 - 7/8" RPA, ERPA, AARP AST25-190 AST25-280 AST25-290 AST25-390 AST25-390 AST25-490 4" RPA, ERPA, AARP AST35-190 AST35-280 AST35-290 AST35-320 AST35-390 AST35-490

#8 Drill Nomenclature DM19AS DM28AS DM29AS DM32AS DM39AS DM49AS

 Head Location
 Side B
 Side B & D
 Side B & C
 Round Pole Only
 Side B, C & D
 Side A, B, C & D

 0.72
 1.39
 1.47
 1.88
 2.09
 2.77
 1.44
 2.16
 2.87

 0.66
 1.28
 1.20
 1.69
 1.87
 2.51
 1.32
 1.98
 2.64

0.74 | 1.44 | 1.57 | 1.96 | 2.18 | 2.88 | 1.48 | 2.23 | 2.97

Round Tenon Mount - Pole Top Slipfitters

Drill Side Location by Configuration Type

RSX4 - Luminaire EPA

RPA - Round Pole Adaptor

MA - Mast Arm Adaptor

ESPA/ERPA - Extended Arm Square/Round Pole

can be ordered as an accessory. equires MVOLT or 347V.

equired for mounting RSX4 in configurations of 2, 3 and 4 at 90°

O Two or more of the following options cannot be combined including PE, DMG, PER7, FAO, DS and NLTAIR2 PIRHN. (Exception: PE and FAO can be combined; also PE and DMG can be combined.)

Compatible with standard twist-lock photocells for dusk to dawn operation or advanced control nodes that provide 0-10V dimming

signals. Wire 4/Wire 5 wired to dimming leads on driver. Wire6/Wire7 capped inside luminaire. Twistlock photocell ordered and shipped as a separate line item from Acuity Brands Controls. See accessories. Shorting Cap included.

For units with option PER7, the mounting must be restricted to +/- 45° from horizontal aim per ANSI C136.10-2010.

De requires (2) separately switched cruits. D. Sprowides 50/50 fixture.

DS requires (2) separately switched circuits. DS provides 50/50 fixture operation via (2) different sets of leads using (2) drivers/sets. DS only available with packages P4, P5, P6, P7 and P8.


Must be ordered with PIRHN.


Requires MVOLI or HVOLI.
 CCE option not available with WBA, WBASC, AASP, AARP, AAWB, AAWBSC, EGS, EGFV and BS.
 Must be ordered with fixture for factory pre-drilling.
 Requires luminaire to be specified with FER7 option. Ordered and shipped as a separate line item from Acuity Brands Controls.

quires MVOLT or HVOLT.


External 360 Full Visor (EGFV)

Must be ordered with NLTAIR2. For additional information on PIRHN

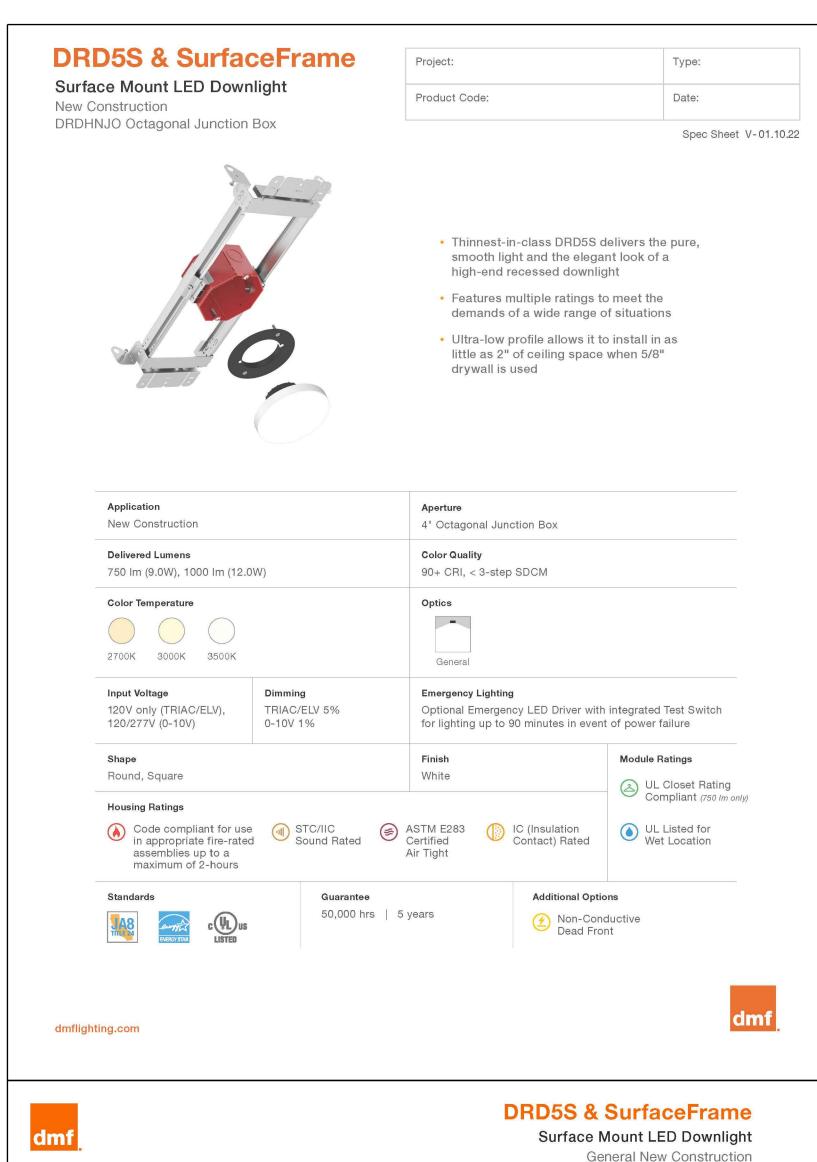

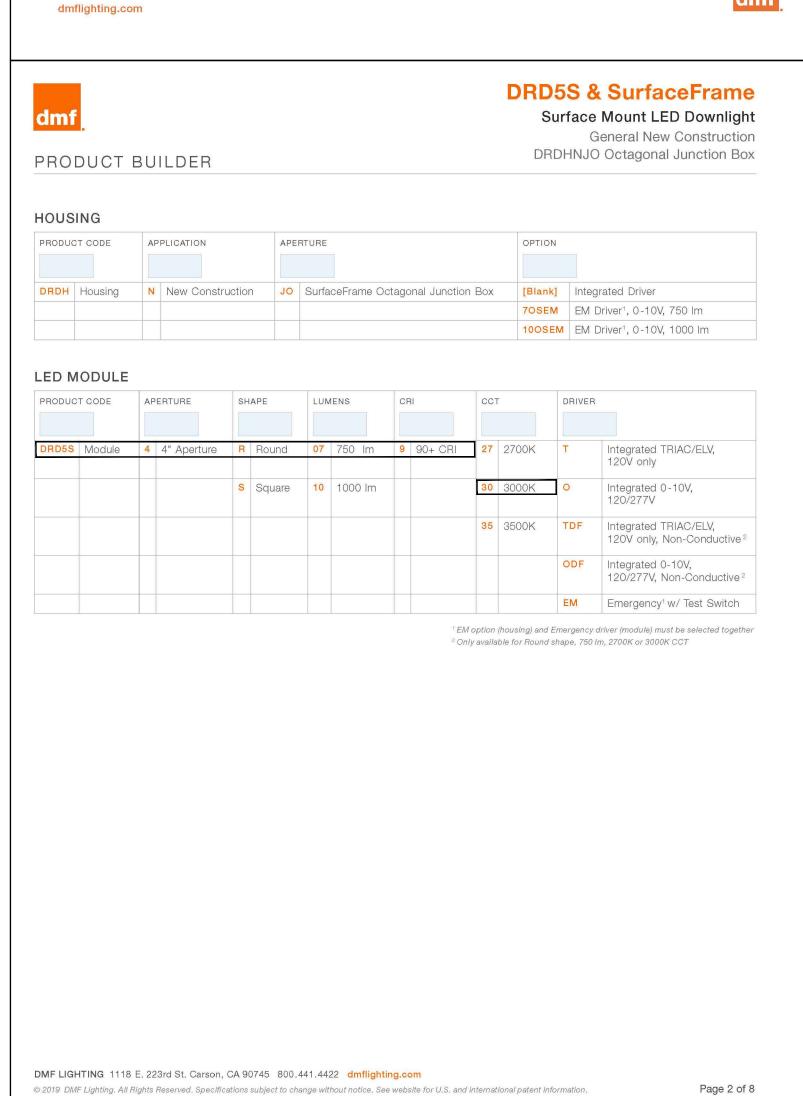



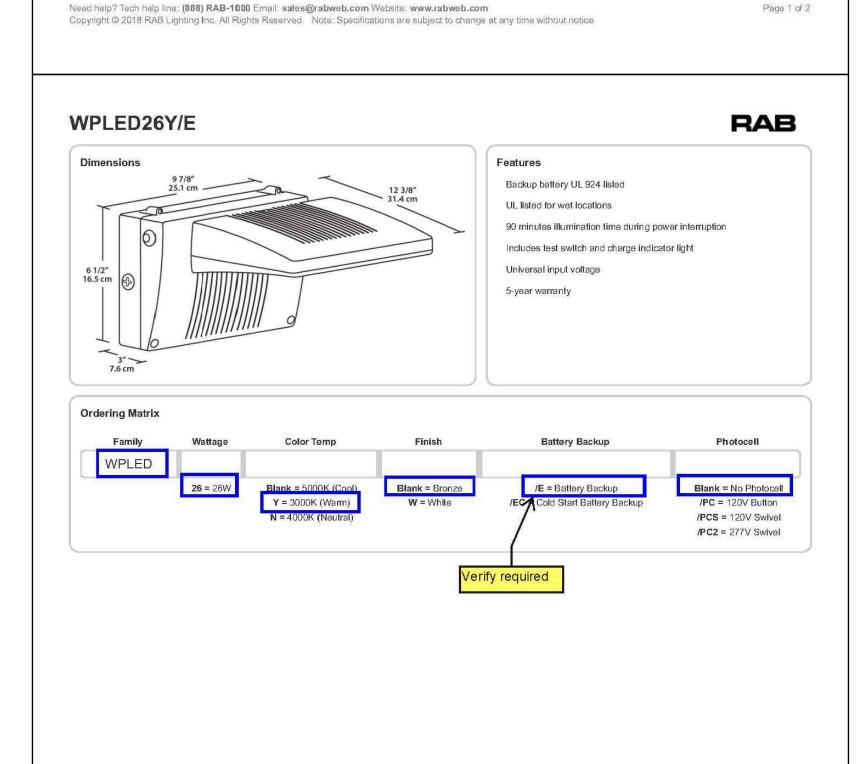


Page 2 of 2

0.4 Amps.

Need help? Tech help line: (888) RAB-1000 Email: sales@rabweb.com Website: www.rabweb.com

Copyright © 2018 RAB Lighting Inc. All Rights Reserved Note: Specifications are subject to change at any time without notice



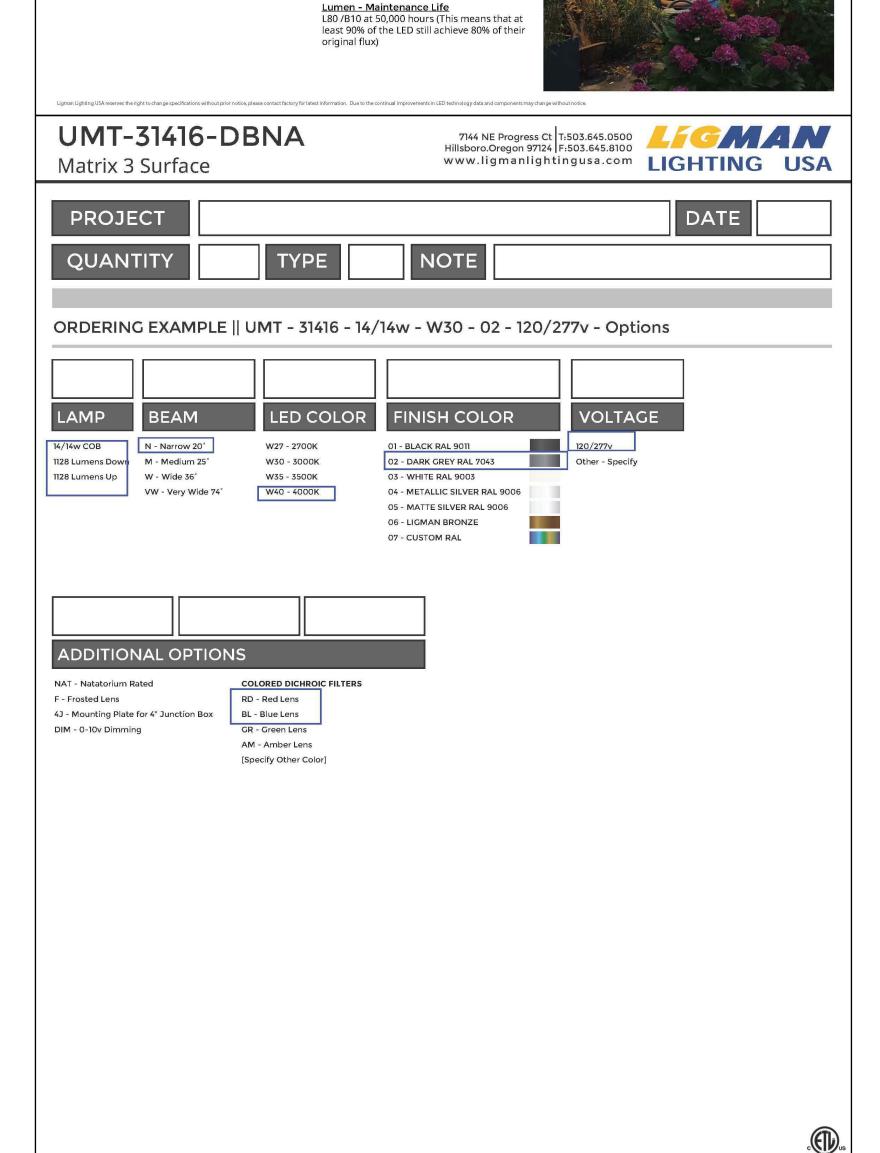



ARMÉT DAVIS NEWLOVE & **ASSOCIATES, AIA ARCHITECTS**

> 1330 OLYMPIC BLVD. SANTA MONICA, CALIFORNIA 90404 PH 310 452-5533 FAX 310 450-4742

THE USE OF THESE PLANS AND SPECIFICATIONS SHALL BE RESTRICTED TO THE ORIGINAL SITE FOR WHICH THEY WERE PREPARED AND PUBLICATION THEREOF IS EXPRESSLY LIMITED TO SUCH USE. RE-USE, REPRODUCTION OR PUBLICATION BY ANY METHOD, IN WHOLE OR IN PART, IS PROHIBITED. TITLE TO THE PLANS AND SPECIFICATIONS REMAINS WITH THE ARCHITECT WITHOUT PREJUDICE. VISUAL CONTACT WITH THESE PLANS AND SPECIFICATIONS SHALL CONSTITUTE PRIMA FACIE EVIDENCE OF THE ACCEPTANCE OF THE RESTRICTIONS.

> **ENGINEERING** 400 N. McCarthy Blvd., Suite 250 Milpitas CA, 95035 ph: (408)522-5255 | fx: (408)522-5260 info@acies.net | Copyright © 2023



0 Coffee COTOTYPE Project Dutch Bros (2550 - A2 PRC

Stor

DATE: 04/28/2023


REV: DATE: DESCRIPTION:


EXTERIOR LIGHTING


SHEET NUMBER:

CUTSHEETS

SHEET NAME:

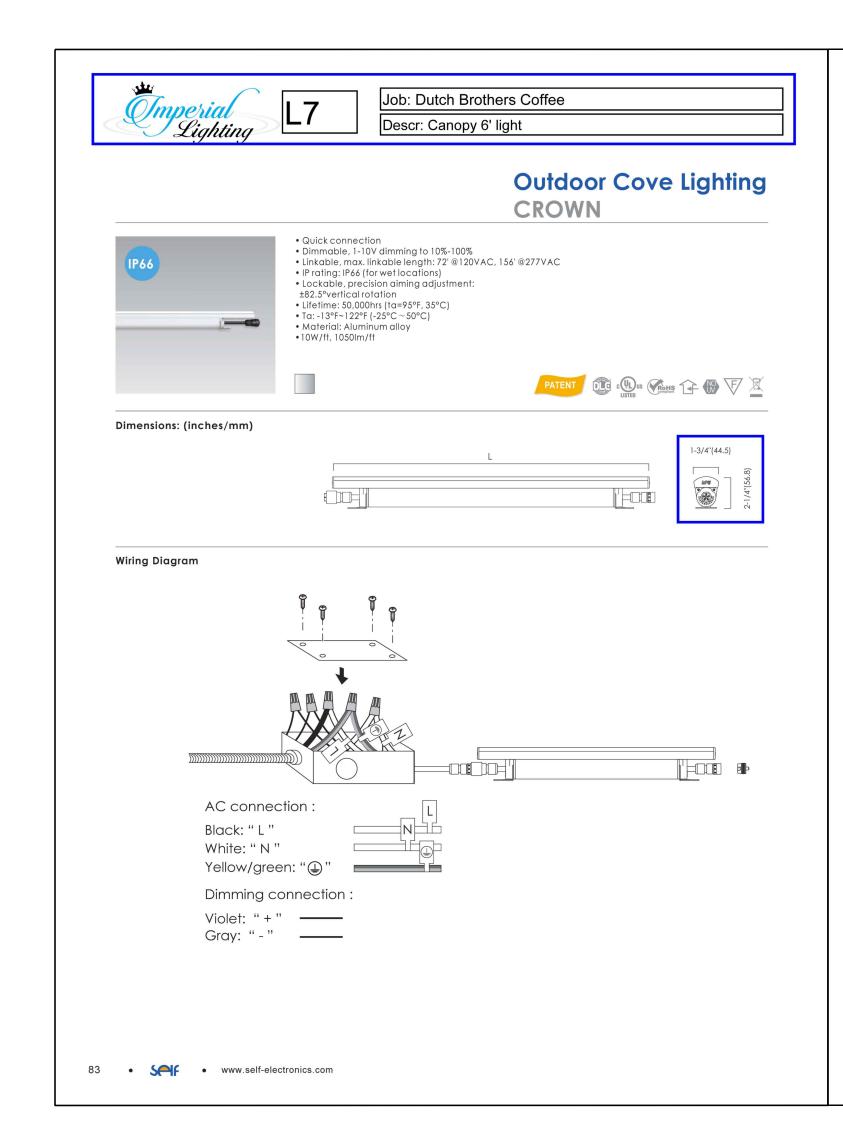

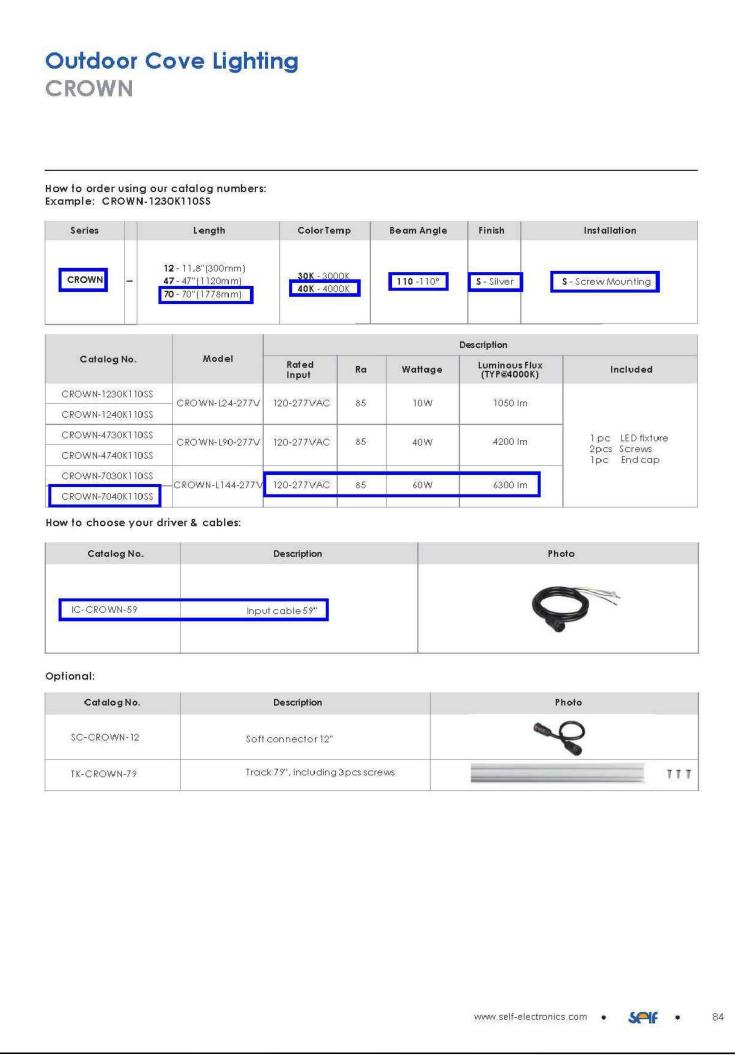

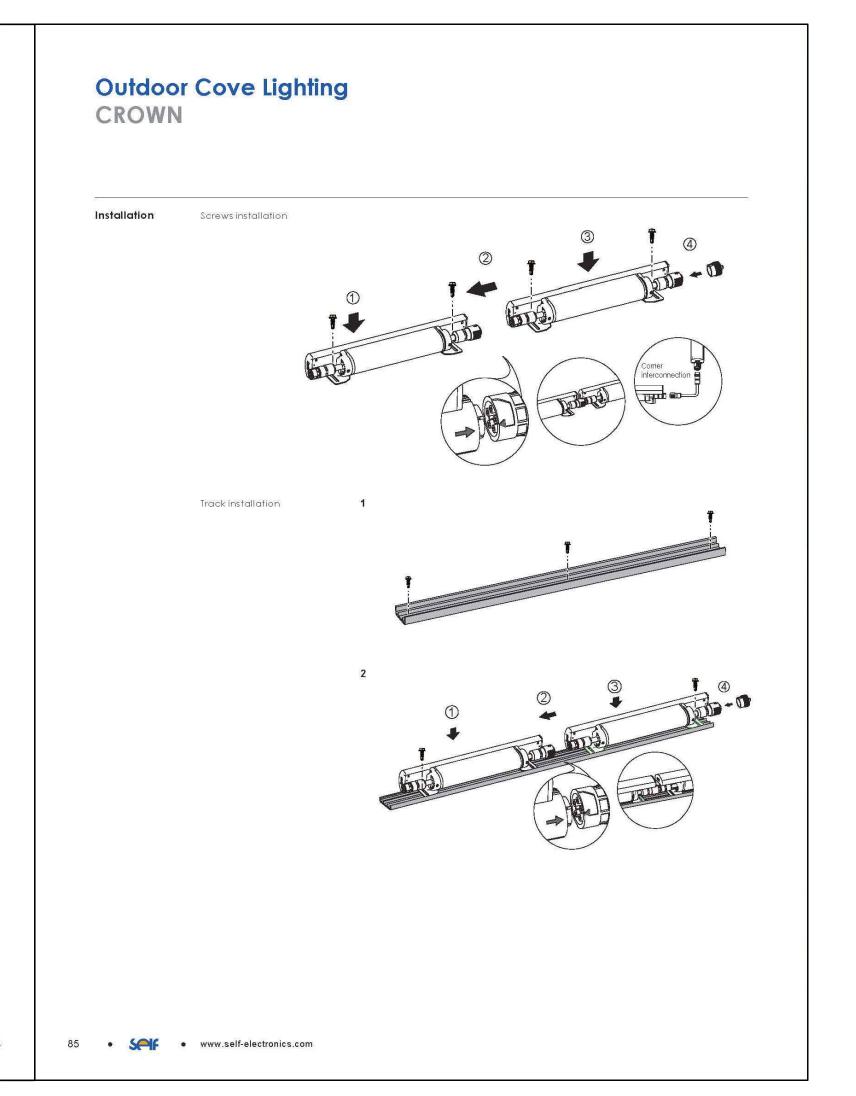



ARMÉT DAVIS NEWLOVE & ASSOCIATES, AIA ARCHITECTS

> 1330 OLYMPIC BLVD. SANTA MONICA, CALIFORNIA 90404 PH 310 452-5533 FAX 310 450-4742

THE USE OF THESE PLANS AND SPECIFICATIONS SHALL BE RESTRICTED TO THE ORIGINAL SITE FOR WHICH THEY WERE PREPARED AND PUBLICATION THEREOF IS EXPRESSLY LIMITED TO SUCH USE. RE-USE, REPRODUCTION OR PUBLICATION BY ANY METHOD, IN WHOLE OR IN PART, IS PROHIBITED. TITLE TO THE PLANS AND SPECIFICATIONS REMAINS WITH THE ARCHITECT WITHOUT PREJUDICE. VISUAL CONTACT WITH THESE PLANS AND SPECIFICATIONS SHALL CONSTITUTE PRIMA FACIE EVIDENCE OF THE ACCEPTANCE OF THE RESTRICTIONS.

ACIES

ENGINEERING

400 N. McCarthy Blvd., Suite 250
Milipitas CA, 95035
ph: (408)522-5255 | fx: (408)522-5260
info@acies.net | Copyright © 2023




47101 Freestanding Store

DATE: 04/28/2023 REV: DATE: DESCRIPTION:


SHEET NAME:

EXTERIOR LIGHTING CUTSHEETS

SHEET NUMBER:

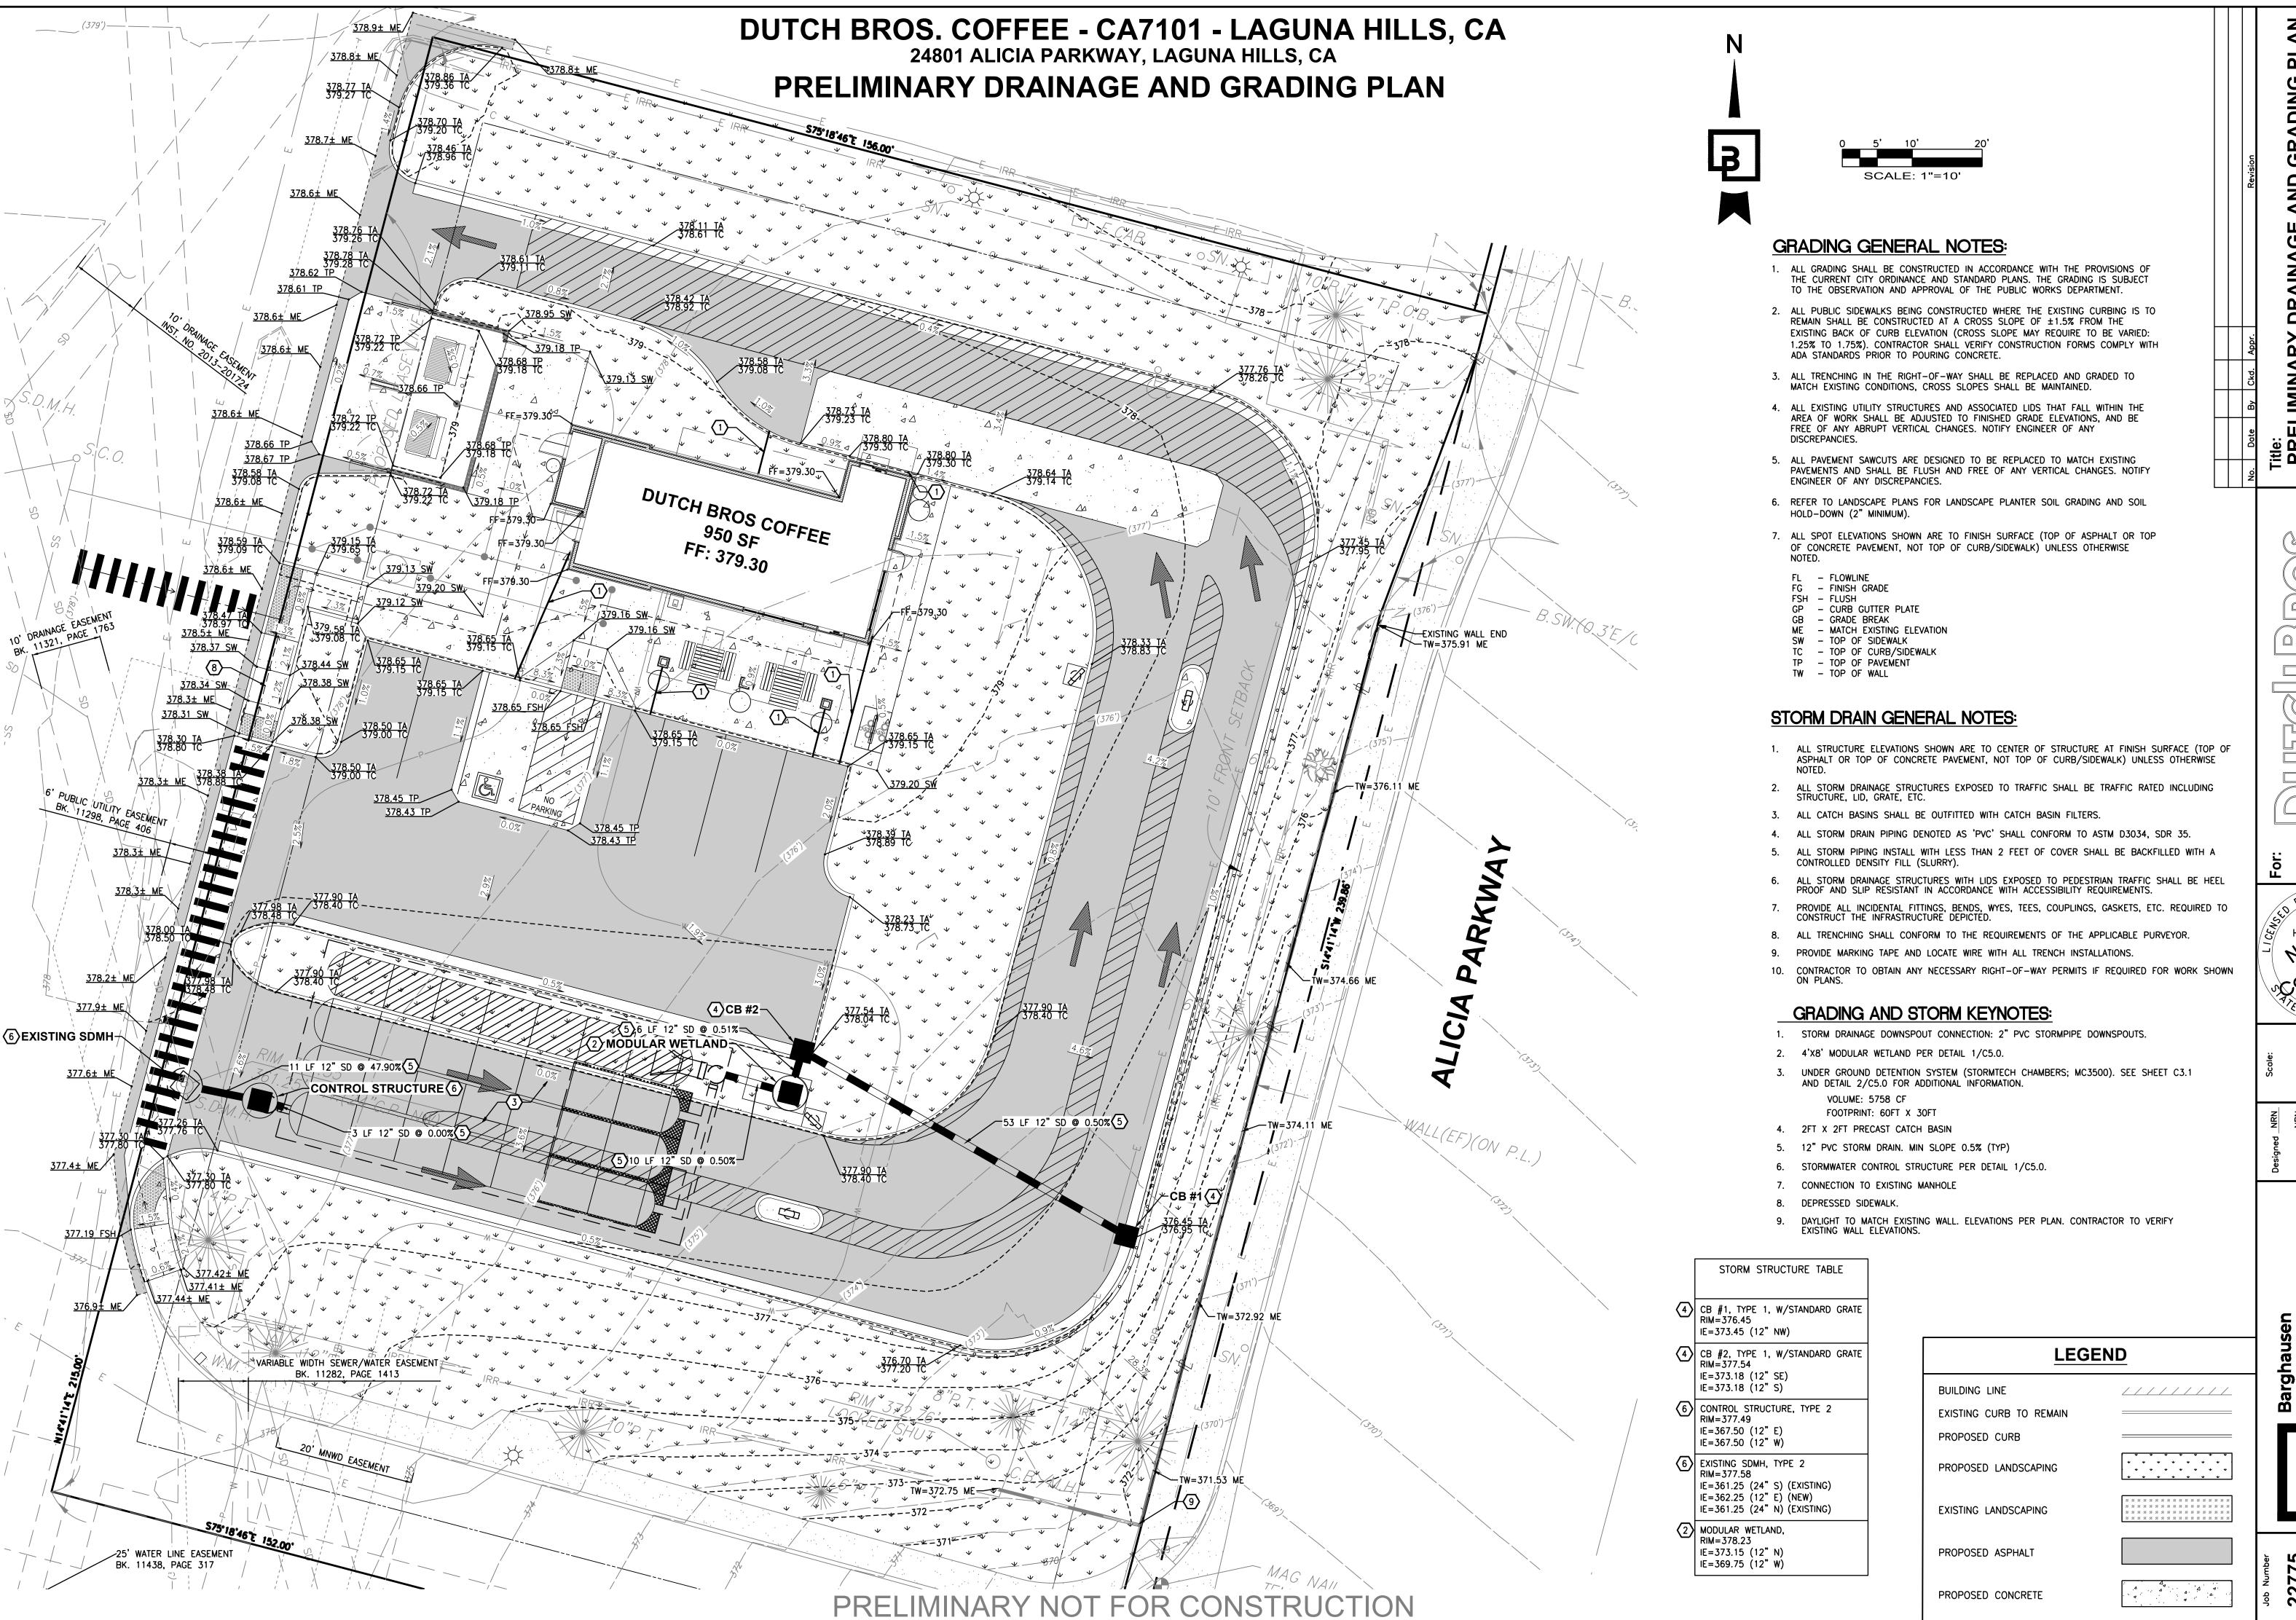

PROFESSION4/

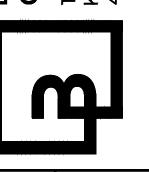

227